

SCOPE OF WORK:

CONSTRUCT 20'W X 80' CONCRETE EXTENSION OF EXISTING DOCK FOR FERRY PASSENGER EMBARKMENT & DISEMBARKMENT

NEW EMBARKMENT / DISSEMBARKMENT RAMP EXTENSION

2

KEY WEST BIGHT FERRY TERMINAL

100 GRINNELL STREET KEY WEST, FLORIDA



ARCHITECT: PIKE ARCHITECTS

471 U.S. HWY. 1, SUITE 101, KEY WEST FLORIDA 305-296-1692

STRUCTURAL ENGINEERING: M. CORDERO & ASSOCIATES CA 6278 **MARCO A. CORDERO: LIC. # 038586**

1227 LAKE MIRIAM DRIVE, LAKELAND, FLA. 33813 863-646-6277

KEY WEST

PROJECT APPROVALS: APPROVAL# DATE EVELOPMENT REVIEW COMMITEE H.A.R.C. BOARD OF ADJUSTMENT CITY OF KEY WEST **DEVELOPEMENT AGREEMENT**


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AND SIGNED BY THE ARCHITECT/ENGINEER

DESIGN NOTES:

THIS STRUCTURE DESIGNED TO **MEET THE FOLLOWING**

FBC 2014 A.S.C.E. 24-05 REGULATIONS LIVE LOAD SEE STRUCTURALS WIND LOAD SEE STRUCTURALS

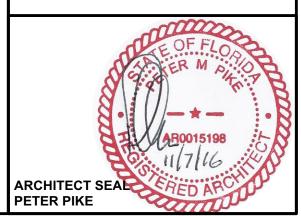

SHEET#

KEY WEST BIGHT BOARD **LOCATION MAP**

NOTES:

PROJEC

DRAWING

DIS STF E

#1 12-29-2016

ARCHITECTS

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> NOTES CALCS. SITE PLAN PROJECT N

PROJECT NUMBER 16.23 DRAWN: KM/TSN CHECKED: PMP DATE: <u>09-19-2016</u>

THIS IS TO CERTIFY THAT I AM A DULY QUALIFIED ARCITECT LICENSED TO PRACTICE IN THE STATE OF FLORIDA. IT IS FURTHER CERTIFIED THAT I HAVE REVIEWED THE DESIGN, SPECIFICATIONS AND PLANS FOR THE COMMERCIAL STRUCTURE PROPOSED FOR CONSTRUCTION AT 100 GRINNELL STREET, KEY WEST FLORIDA, AND IS IN COMPLIANCE WITH THE ORDINANCE ADOPTED BY THE CITY OF KEY WEST, MONROE COUNTY NO. 87-17 REGARDING COASTAL CONSTRUCTION REQUIREMENTS IN THE CITY OF KEY WEST, IN THAT THE STRUCTURE IS DESIGNED ON ADEQUATELY ANCHORED PILINGS OR COLUMNS AND IS SECURELY ANCHORED TO SAME IN ORDER TO WITHSTAND VELOCITY WATERS AND HURICANE WAVE WASH ASSOCIATED WITH THE BASE FLOOD FLOW.

LOWEST FINISHED FLOOD ELEVATION- VE 10' N.G.V.D. SEAL


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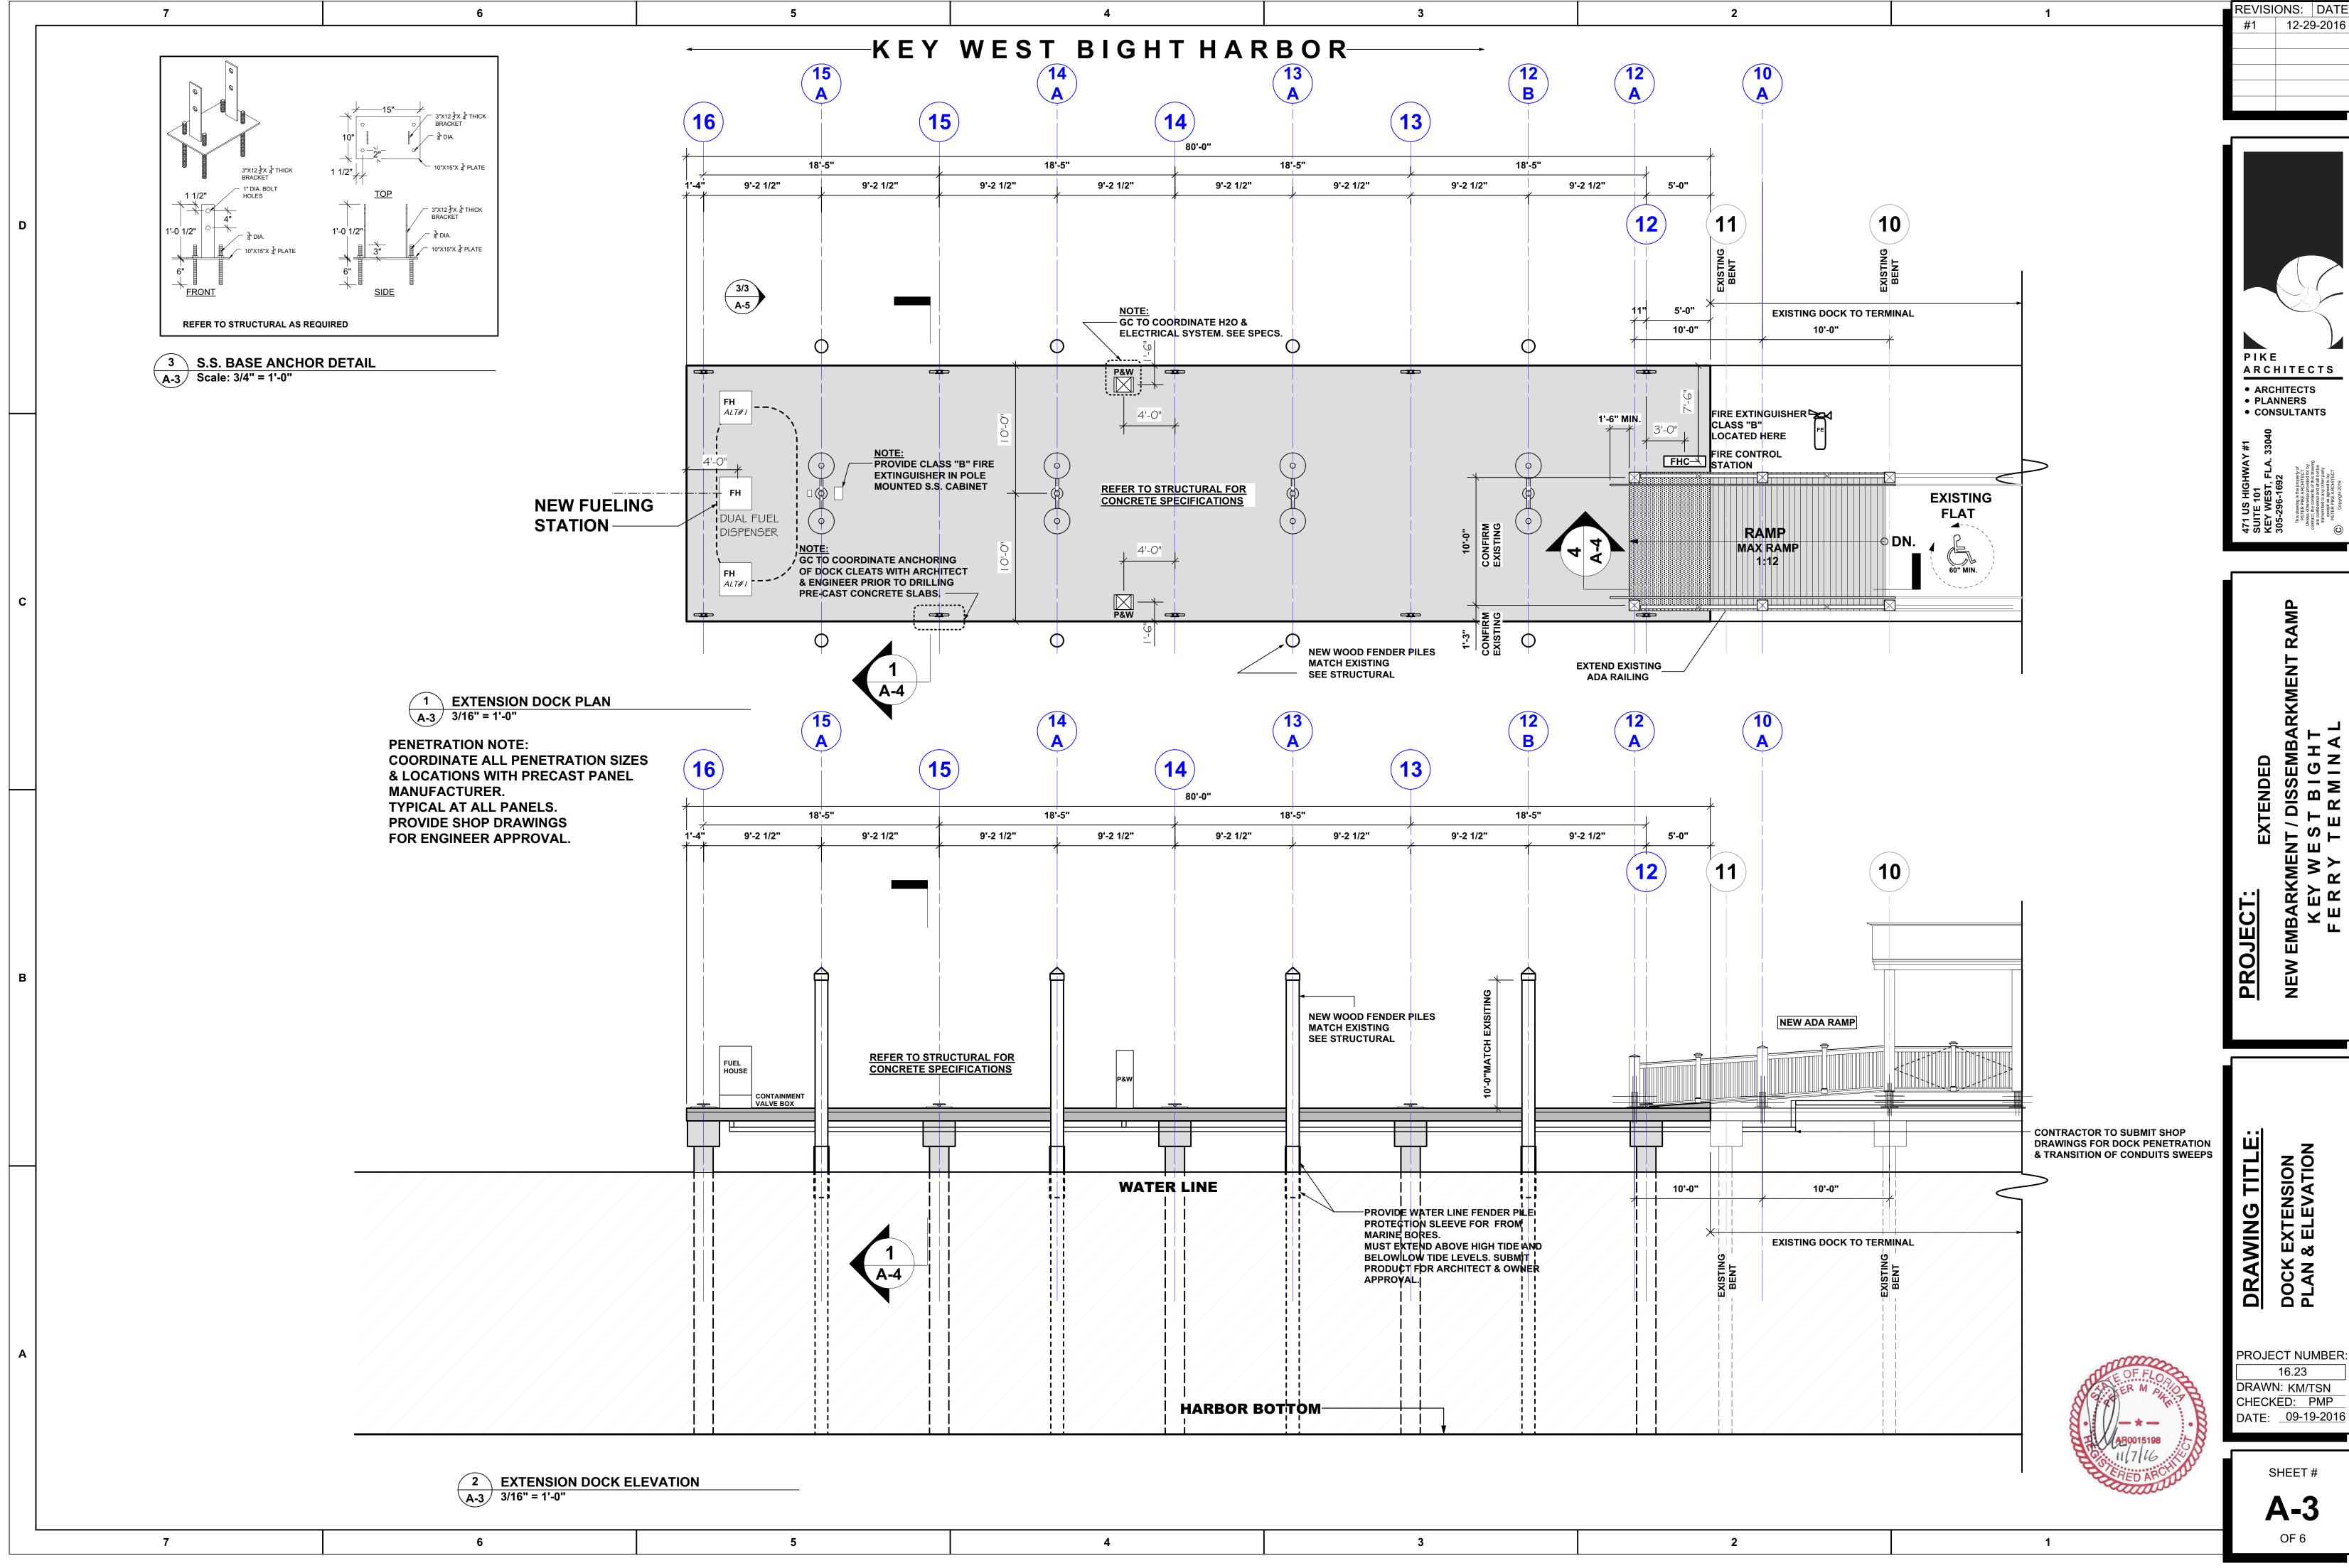
CERTIFICATE OF COMPLIANCE

LEGAL DESCRIPTION:

A parcel of Submerged land lying and being in Section 31, Township 68 South Range 25 East, Island of Key West, Monroe County, Florida, and a part of Key West Bight and being more particularly described as follows: Commencing at the intersection of the Northwesterly Right-of-Way Line of Caroline Street and the Southwesterly Right-of-Way Line of Grinnell Street; thence N.33°58'50"W., along the said Southwesterly Right-of-Way Line of William Street a distance of 351.85 feet to the seaward face of a concrete seawall lying on the Key West Bight and the Point of Beginning; thence continue N 33°58'50" W along the Northerly extension of the Southwesterly Right-of-Way Line of Grinnel Street for 431.59 feet to the federally Maintained Shipping Channel Line; thence S 86°27'30" E and along the said Federally Maintained Shipping Channel Line for a distance of 439.01 feet; thence N 05°58'10" E for 156.10 feet; thence N 84° 01'50" W for 40.00 feet; thence N 05°58'10" E for 145.04 feet; thence S 82°58'21" E for 106.23 feet to the Approximate Mean High Water line (Elev. 0.92 N.G.V.D., 1929); thence meander the said Mean High Water Line in a Southerly direction for 558.2 feet, more or less to the face a Concrete Seawall; thence N 81°29'40" W along the said concrete seawall for a distance of 112.13 feet, more or less; thence S 56°50'27" W and continuing along the face of the concrete seawall for 151.65 feet to the Point of

Beginning.
Parcel contains 134125 square feet or 3.08 acres, more or less.



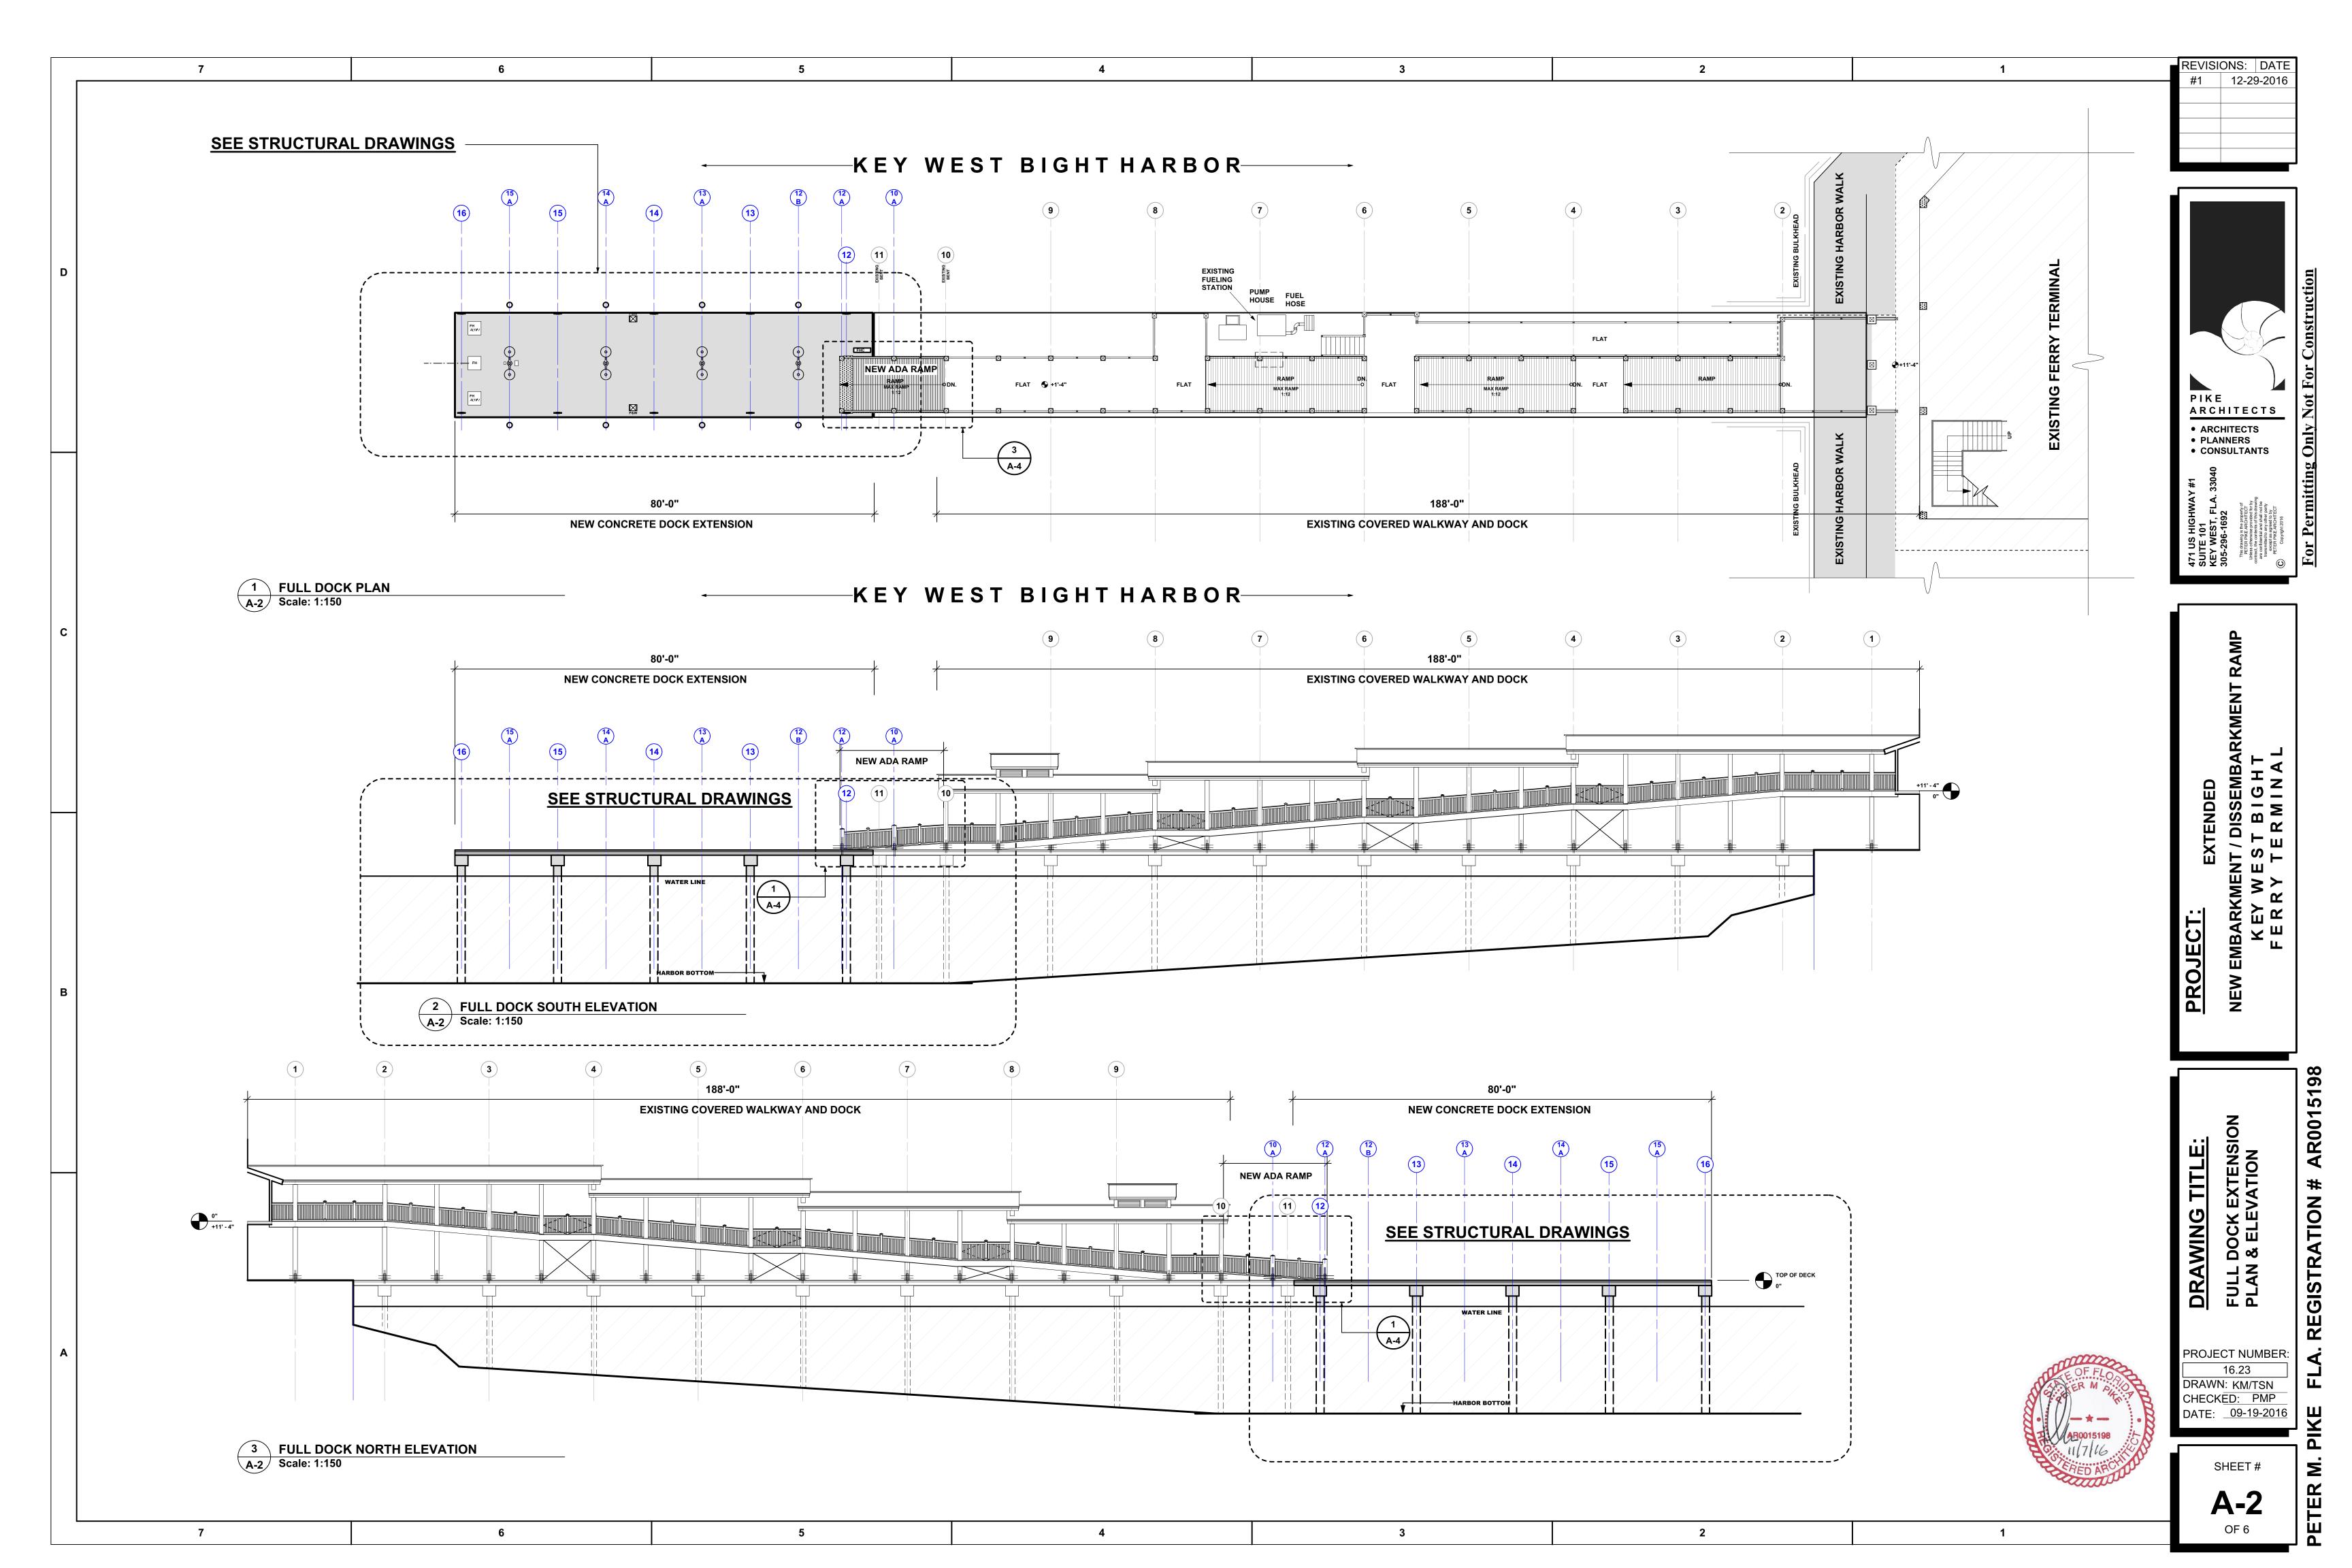


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DOCK

PROJECT NUMBER: DRAWN: KM/TSN

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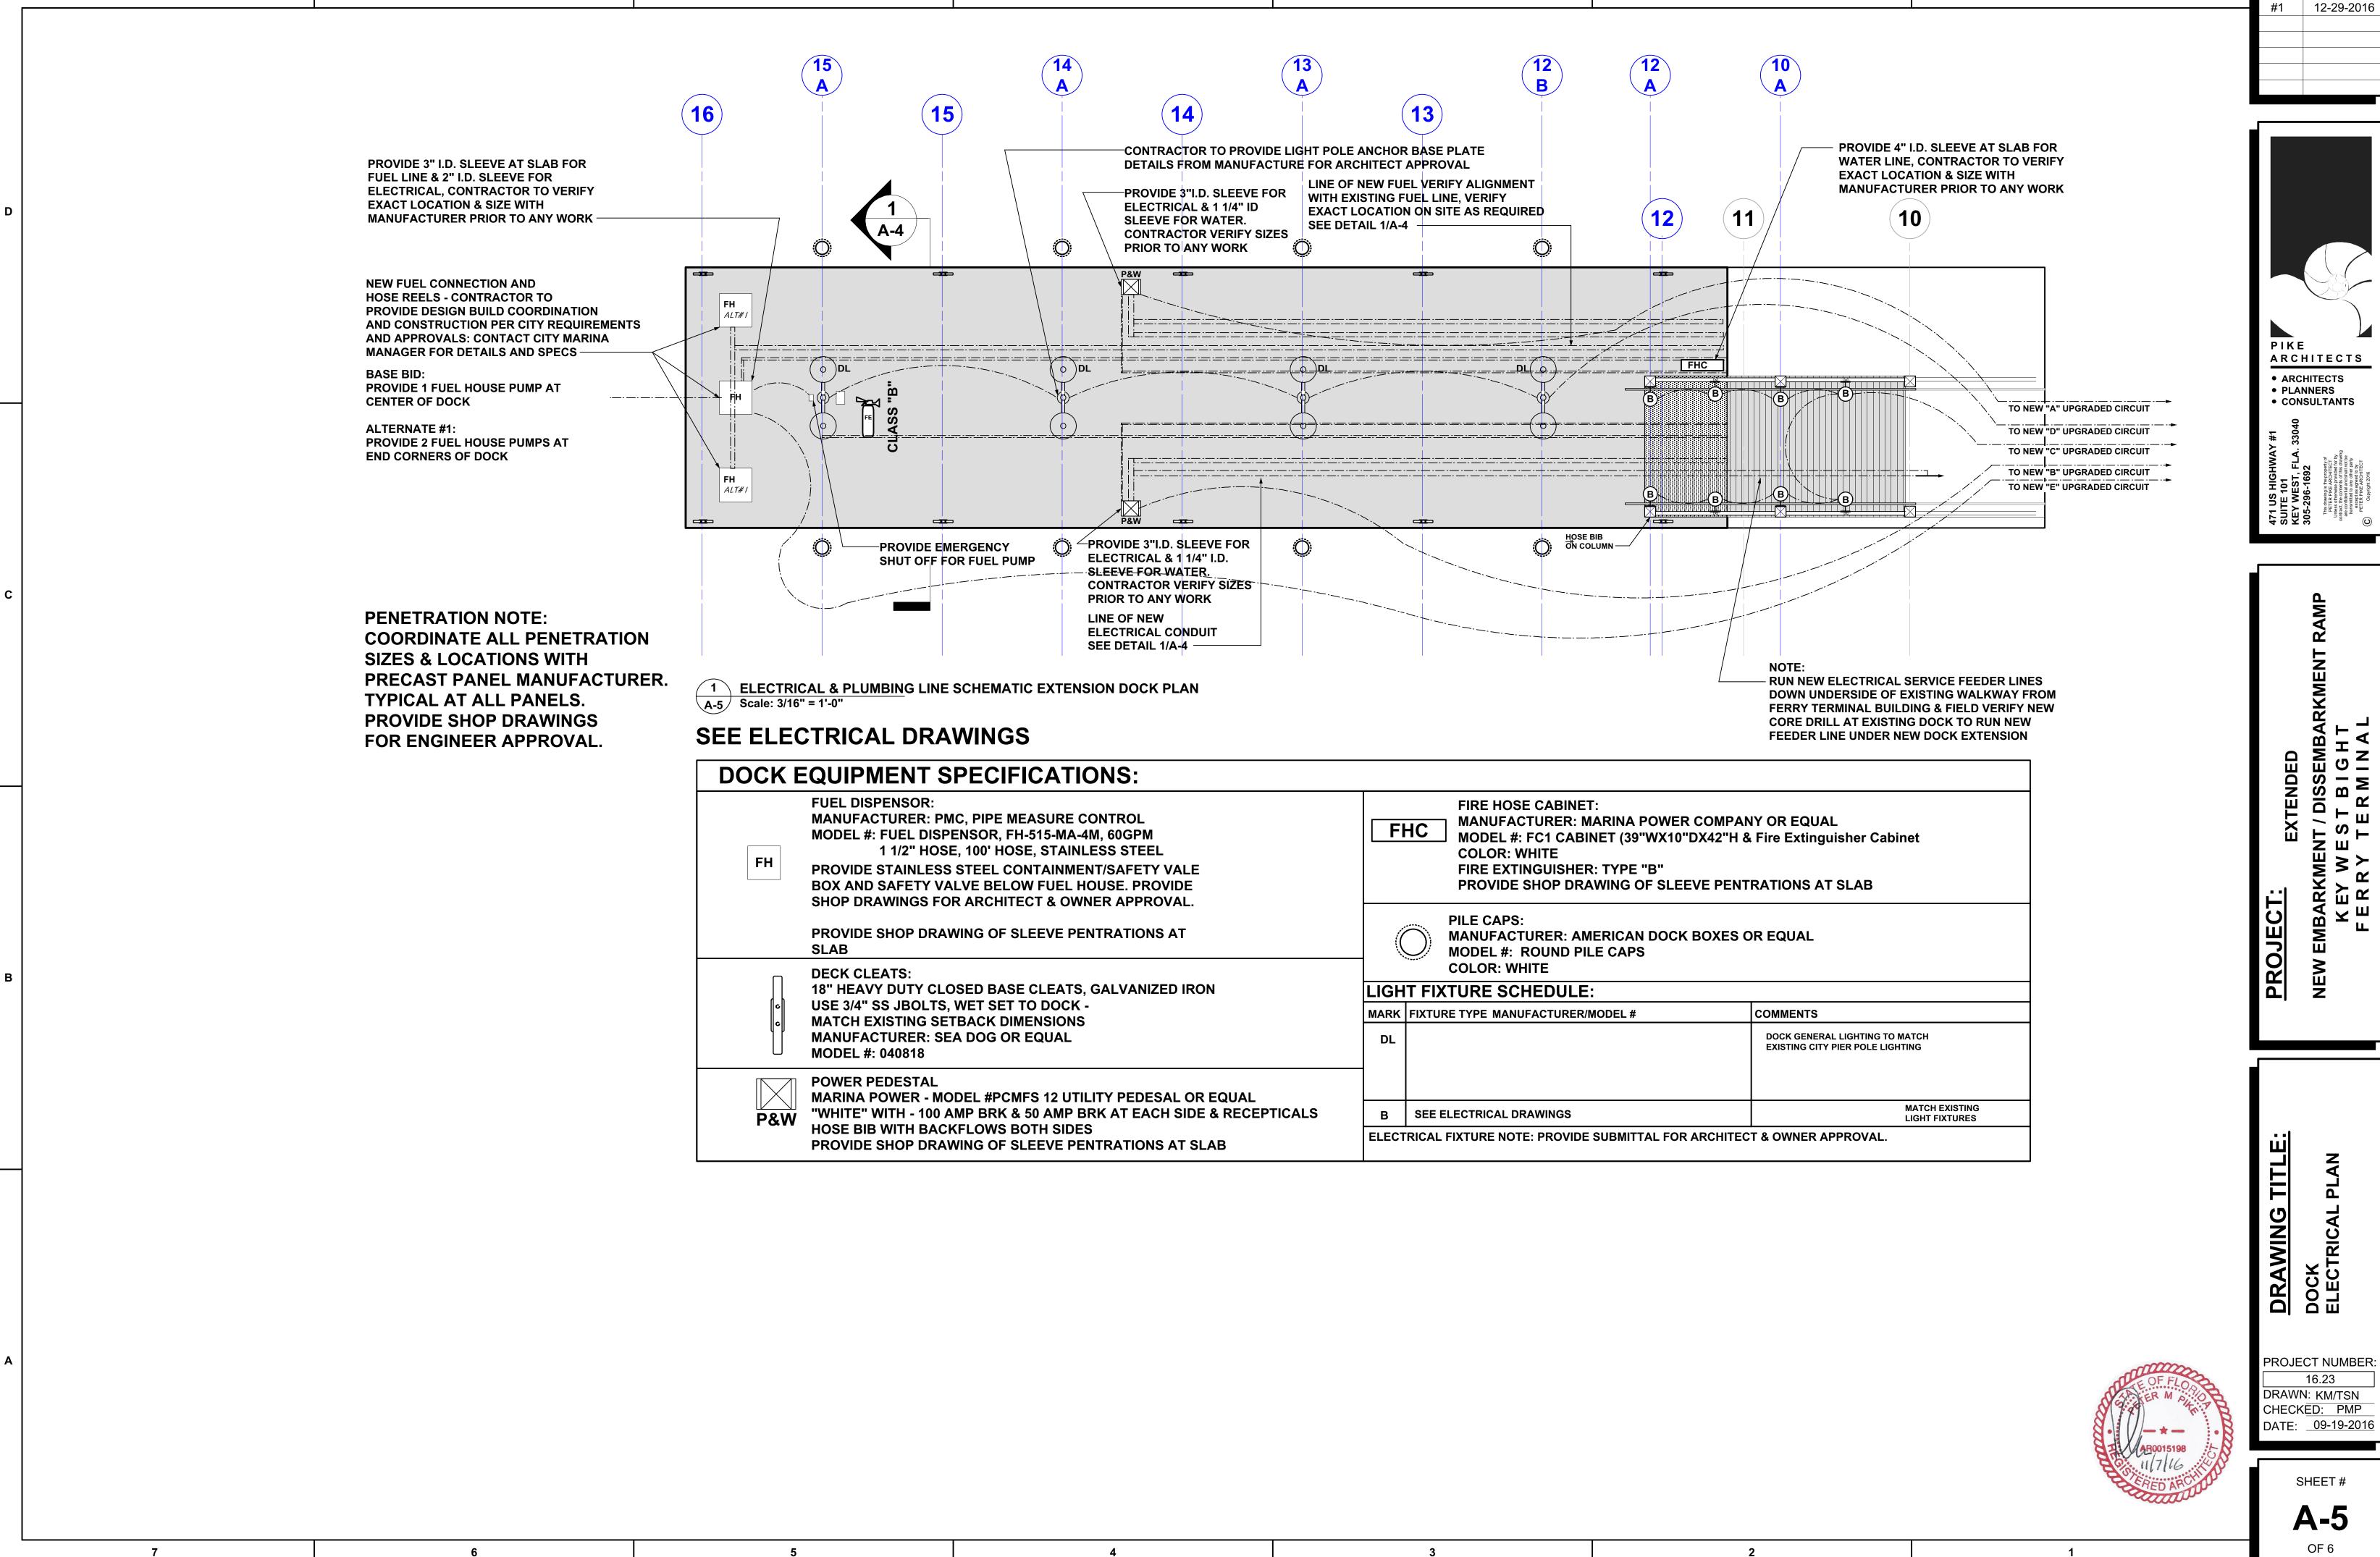
AR0015198

REGISTRATION

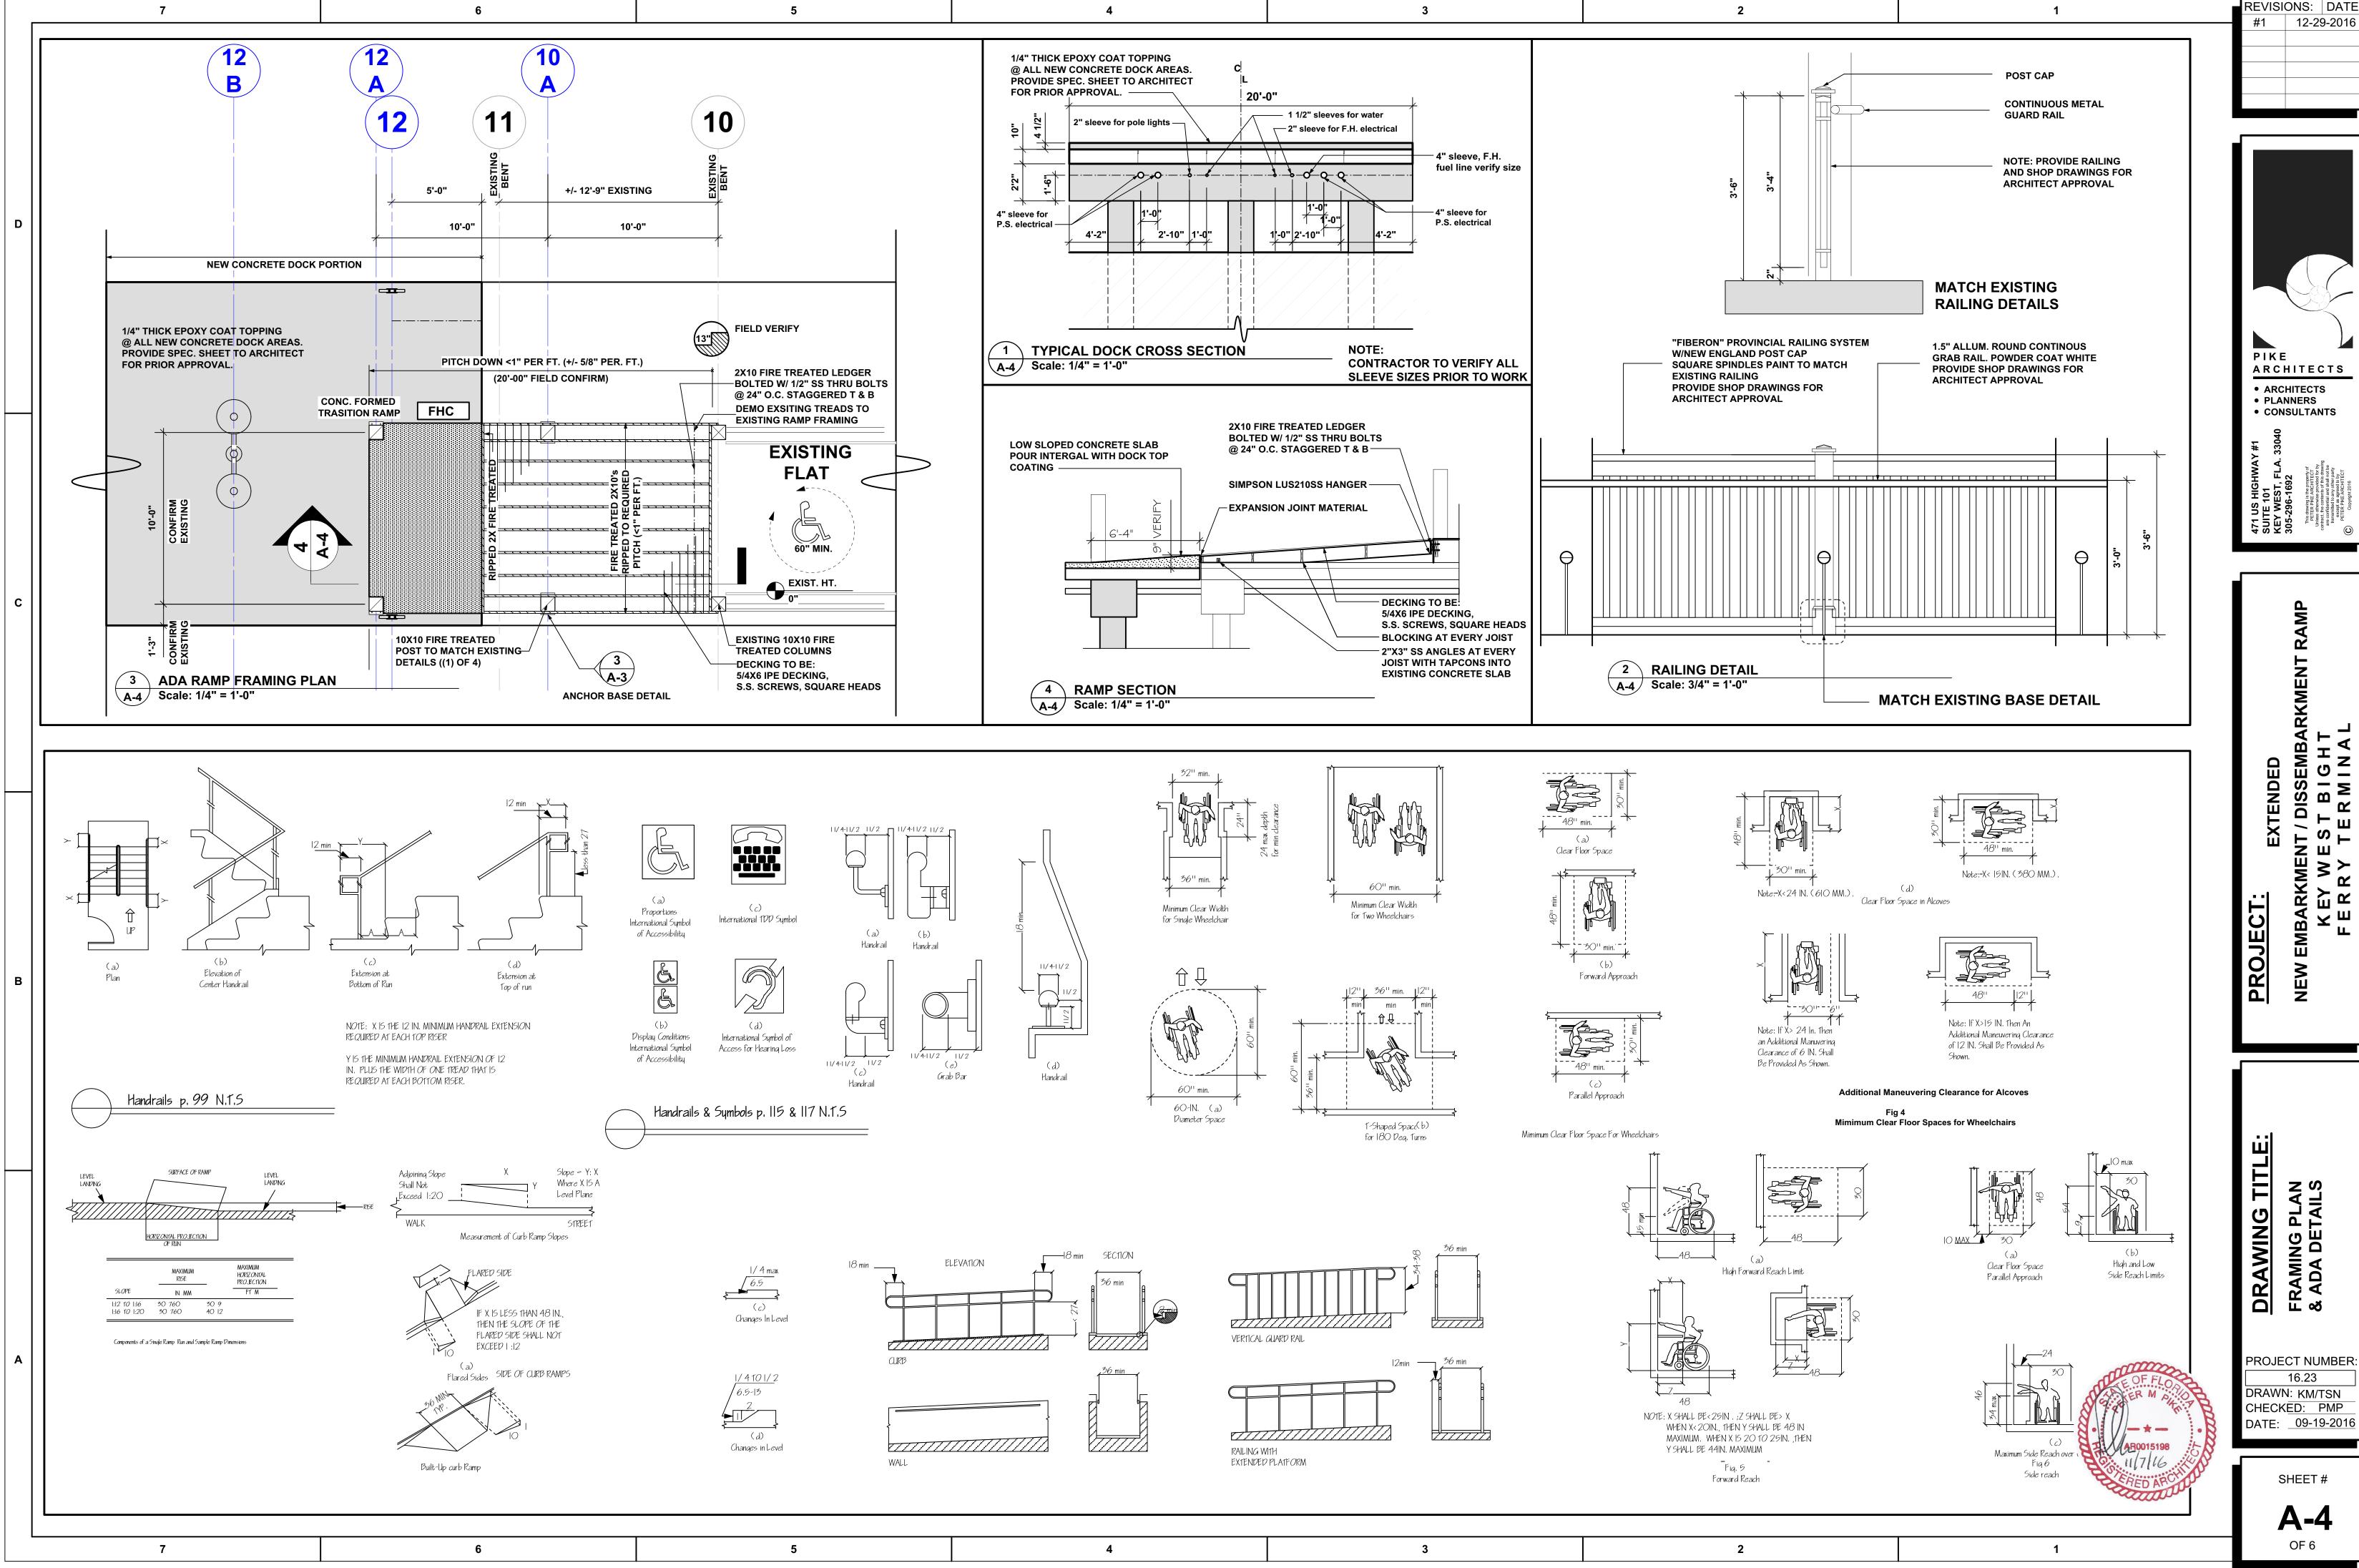PROJECT NUMBER: 16.23 DRAWN: KM/TSN CHECKED: PMP DATE: <u>09-19-2016</u>

SHEET#

A-4



REVISIONS: DATE

ENVIRONMENTAL NOTES AND SPECIFICATIONS

- 1. The Contractor shall review environmental requirements of any proposed staging areas with the Miami Dade County Project Engineer (INSERT PROJECT ENGINEER NAME & NUMBER) at least seventy-two (72) hours prior to use.
- 2. No staging or any other activities for this project will be allowed within or adjacent to Key West Bight, seagrass beds, or mangroves except as explicitly shown on the Contract Plans and permitted by the regulatory agencies.
- 3. Mangroves exist along the shoreline along Trumbo Road. Any trimming or disturbance to mangroves shall comply with Sec 403.9321-9333 F.S., "Mangrove Trimming and Preservation Act"; A Professional Mangrove Trimmer, designated per 403.9329 F.S., shall be present on site throughout the duration of all mangrove trimming or disturbance activities. The Contractor shall coordinate with the Miami Dade County Project Engineer (LAP AGENCY TO INSERT NAME AND NUMBER FOR REPRESENTATIVE) at least seventy-two (72) hours in advance to obtain approval for these activities.
- 4. This project is within the Florida Keys National Marine Sanctuary, which is designated as Outstanding Florida Waters (OFW). The project must comply with the turbidity requirements of the OFW designation including: no degradation of water quality; no increased turbidity of the water; and turbidity levels beyond the turbidity control measures cannot exceed 0 Nephelometric Turbidity Units (NTUs) above background levels.
- 5. The following Federal and State listed animal species could inhabit or migrate through the construction area: West Indian manatee (endangered), piping plover (threatened), marine turtles (endangered), smalltooth sawfish (endangered), roseate tern (threatened) and American crocodile (threatened). The Contractor shall comply with all Federal and State requirements regarding endangered and threatened species and State listed species of special concern. Should these species be encountered, the Contractor shall contact the Miami Dade County Project Engineer (INSERT PROJECT ENGINEER NAME & NUMBER) within 24 hours of each encounter.

General Comments/Notes to Designer:

Based on a desktop review of DERM and FDEP GIS layers, there are (2) facilities with known contamination within a 300-ft buffer of the project (see list below). Due to the scope of this project and the location of the facility, a more detailed Phase I (Level I) Environmental Site Assessment (ESA) is not necessary at this time. Should the project limits or the scope of work change, a Phase I (Level I) ESA and subsequent Phase II (Level II) ESA may be necessary. Please include the attached notes addressing unidentified areas of contamination during construction in the contract plans.

LIST OF KNOWN AND POTENTIAL CONTAMINATED SITES

- 1. Key West Bight Terminal, 201 Grinnell St, FDEP #9802172
- 2. Conch Harbor Marina, 951 Caroline St, FDEP #8735043

UNIDENTIFIED AREAS OF CONTAMINATION

When encountering or exposing any abnormal condition indicating the presence of a hazardous or toxic waste, or contaminants, cease operations immediately in the vicinity and notify the City of Key West Engineer. The presence of tanks or barrels; discolored earth, metal, wood, ground water, etc.; visible fumes; abnormal odors; excessively hot earth; smoke; or other conditions that appear abnormal may indicate hazardous or toxic wastes or contaminants and must be treated with extreme caution.

Make every effort to minimize the spread of contamination into uncontaminated areas. Immediately provide for the health and safety of all workers at the job site and make provisions necessary for the health and safety of the public that may be exposed to any potentially hazardous conditions. Provisions shall meet all applicable local, State, and Federal laws, rules, regulations or codes covering hazardous conditions and will be in a manner commensurate with the gravity of the conditions.

The City of Key West Engineer and/or Prime Contractor will coordinate and mobilize a qualified Contamination Assessment/Remediation (CAR) Contractor. Qualifications of such CAR Contractor shall include: experience and personnel to prepare contamination assessment plans, conduct contamination assessments, prepare site assessment reports, implement remedial action plans, risk based corrective actions or any other type of environmental assessment or remedial activities as necessary.

All the work performed by the CAR Contractor shall be performed in compliance with all applicable local, state and federal regulations governing worker safety and environmental regulations. This is to include occupational exposure to contaminated soils, groundwater, wastes and atmosphere during the construction of all features included in the construction plans. In addition, the CAR Contractor must be staffed with Florida licensed technical professionals (geologists and engineers) who will be involved with the project and howledgeable of the work activities conducted within the identified contaminated areas and who would sign and seal project reports as required for submittal to the appropriate environmental regulatory agencies.

The City of Key West Engineer will immediately notify the Florida Department of Transportation (FDOT) District VI Contamination Impact Coordinator (DCIC) at (305) 470-5228 after encountering the unidentified areas of contamination. Preliminary investigation by the CAR Contractor will determine the course of action necessary for site security and the steps necessary under applicable laws, rules, and regulations for additional assessment and/or remediation work to resolve the contamination issue.

Following completion of the project, the CAR Contractor shall be required to provide copies of all reports submitted to regulatory agencies, waste material profiles, manifests and/or disposal receipts for the handling of all contaminated media including but not limited to ground water, waste water, soils, solid wastes, sludge, hazardous wastes, air monitoring records and sample results for all materials tested and analyzed to the City of Key West Engineer and the FDOT DCIC.

TURBIDITY BARRIER NOTES AND SPECIFICATIONS

NOTE: ENTITE PROJECT TO BE PROTECTED VIA IMPLIMENTATION OF A TURBIDITY BARRIER AND ENVIORMENTAL PROTECTION PLAN AS REQUIRED BY LOCAL, STATE AND FEDEWRAL LAW

ARCHITECTURAL SPECIFICATIONS

1. THE GENERAL CONDITIONS OF THE CONTRACT FOR CONSTRUCTION, AIA DOCUMENT A201, ARE A PART OF THIS PROJECT. CONTRACTORS WHO ARE NOT FAMILIAR WITH THIS DOCUMENT MAY OBTAIN COPIES FROM THE ARCHITECT, OR THE OFFICE OF THE AMERICAN INSTITUTE OF ARCHITECTS, MIAMI, FLORIDA. OWNER MAY SUBSTITUTE CONTRACT FOR CONSTRUCTION OTHER THAN AIA 201. 2. ALL WORK SHALL BE IN STRICT CONFORMITY WITH THE FLORIDA BUILDING CODE. LATEST EDITION. AND WITH ALL APPLICABLE LAWS, CODES AND ORDINANCES OF THE CITY, COUNTY, STATE, UTILITY

COMPANIES AND ANY OTHER GOVERNING AGENCIES. . THE CONTRACT WORK INCLUDES ALL MATERIAL, EQUIPMENT, TOOLS, LABOR AND SERVICES NECESSARY FOR THE COMPLETION OF THE PROJECT. THE OWNER HAS THE RIGHT TO, AND EXPECTS ALL WORK TO BE COMPLETED AS EXPEDITIOUSLY AS QUALITY WORKMANSHIP SHALL ALLOW 4. THE CONTRACTOR SHALL PROCURE AND PAY FOR ALL NECESSARY BUILDING PERMITS AND FOR INSPECTION

SERVICES OF LOCAL AUTHORITIES WHERE REQUIRED BY LAW NOTIFY ALL UTILITY COMPANIES PRIOR TO EXCAVATION FOR LOCATION OF UNDERGROUND UTILITIES. AND/OR PROTECTION OR REMOVAL OF OVERHEAD POWER LINES AND POLES. 6. PROVIDE SAFETY BARRICADES, SIGNALS, FENCES, ETC., AS REQUIRED FOR THE SAFE EXECUTION OF

7. THE OBSERVATION OF THE CONTRACT WORK SHALL BE DONE BY THE PERSON LISTED IN THE CONTRACT AGREEMENT AS THE ARCHITECT. IN THE CASE THAT NO OBSERVATION BY THE ARCHITECT IS PROVIDED IN THE CONTRACT, THE FUNCTIONS OF THE ARCHITECT, WHEREVER CALL FOR IN THE SPECIFICATIONS, SHALL BE EXERCISED BY THE OWNER.

8. THE CONTRACTOR SHALL PROVIDE A TEMPORARY INSTALLATION OF ELECTRIC SERVICE IF SUCH SERVICE IS NOT AVAILABLE ON SITE 9. MATERIALS AND LABOR

9.1 SUBMIT SAMPLES TO THE ARCHITECT FOR APPROVAL OF COLOR WHERE REQUIRED. 9.2 ALL WORK SHALL BE PERFORMED IN THE BEST AND MOST PROFESSIONAL MANNER BY MECHANICS SKILLED IN THEIR RESPECTIVE TRADES

9.3 WHERE BRAND NAMES OR MANUFACTURERS NAMES APPEAR, THEY ARE USED TO ESTABLISH A QUALITY OF MATERIAL AND/OR PROCESS. SUBSTITUTIONS WILL BE APPROVED BY THE ARCHITECT IF, IN HIS JUDGMENT, THEY CONSTITUTE AN EQUAL MATERIAL OR PROCESS 9.4 ALL TRADES SHALL GUARANTEE ALL WORK TO BE FREE OF DEFECTS IN MATERIALS OR WORKMANSHIP FOR A PERIOD OF ONE (1) YEAR FROM THE DATE OF FINAL ACCEPTANCE.

9.5 APPLY, INSTALL, CONNECT, ERECT, CLEAN, CONDITION, AND USE ALL MANUFACTURED ARTICLES IN ACCORDANCE WITH THE MANUFACTURERS INSTRUCTIONS AND AS SHOWN ON THE DRAWINGS. PROVIDE OWNER WITH ALL GUARANTEES AND MAINTENANCE MANUALS FOR ALL APPLIANCES AND PIECED OF EQUIPMENT

10.1 BY SUBMITTING A BID. THE BIDDER AGREES AND WARRANTS THAT HE HAS EXAMINED THE DRAWINGS AND SPECIFICATIONS AND FOUND THAT THEY ARE ADEQUATE FOR THE PROPER COMPLETION OF THE PROJECT. 10.2 NO CLAIMS FOR ANY EXTRA CHARGES WILL BE ALLOWED BECAUSE OF ALLEGED IMPOSSIBILITIES DUE TO INADEQUATE DRAWINGS OR SPECIFICATIONS

10.3 THE CONTRACTOR SHALL BE RESPONSIBLE FOR VERIFYING FIELD MEASUREMENTS BEFORE ORDERING MATERIALS AND PREFABRICATED ITEMS. ANY NECESSARY ADJUSTMENTS BETWEEN FIELD MEASUREMENTS AND DRAWINGS SHALL BE MADE AS PER THE DECISION OF THE ARCHITECT 11. PAYMENTS

PER CONTRACT WITH OWNER

12.1 THE CONTRACTOR SHALL CARRY WORKMEN COMPENSATION INSURANCE TO THE EXTENT REQUIRED BY LAW AND SHALL MAINTAIN SUCH INSURANCE IN FULL FORCE DURING THE ENTIRE TIME OF THIS CONTRACT. 12.2 THE CONTRACTOR SHALL CARRY COMPREHENSIVE GENERAL AND AUTOMOTIVE LIABILITY INSURANCE

13.1 ALL WORK SHALL BE SUBSTANTIALLY COMPLETED AT A TIME STIPULATED IN THE CONTRACT AGREEMEN OR IN TIME EXTENDED FOR JUSTIFIABLE DELAYS, IF ANY 13.2 A BUILDING OR ANY OTHER WORK SHALL BE CONSIDERED SUBSTANTIALLY COMPLETED WHEN NINETY-FIVE PERCENT (95%) OF THE WORK IS DONE AND THE BUILDING IS READY FOR OCCUPANCY OR THE

CONCRETE EPOXY COATING TO MATCH EXISTING COLOR,

TEXTURE AND APPLICATION

6.1 FINISHED FLOOR SLAB SURFACES SHALL BE PLANE SURFACES AS SHOWN ON THE DRAWINGS. WHERE DRAINS OCCUR SLOPE 6.2 INTERIOR SLABS SHALL BE SCREEDED WITH A STRAIGHT EDGE, FLOATED TO THE REQUIRED LEVEL, AND STEEL TROWELED TO A

SMOOTH HARD FINISH.EXTERIOR SLABS SHALL BE BROOM FINISHED. 3.3 CONCRETE FLOORS SHALL BE CHECKED FOR TRUENESS WITH AN 8 FOOT STRAIGHT EDGE. ANY DEVIATION FROM THE LINE OF THE STRAIGHT EDGE BY MORE THAN 1/4" SHALL BE REPAIRED IN A MANNER SATISFACTORY TO THE ARCHITECT. . AFTER CONSTRUCTION IS COMPLETED, THOROUGHLY CLEAN ALL EXPOSED FLOORS WITH SOAP AND WATER.

8 CONTROL JOINTS SHALL BE FORMED AS INDICATED ON DRAWINGS OR FORMED WITH METAL KEYWAY TO REMAIN IN THE SLAB.SLABS WITH AN APPROVED LIQUID CURING COMPOUND AND SEALING AGENT. APPLIED IN ACCORDANCE WITH THE

1. SCOPE: FURNISH AND INSTALL ALL LABOR, MATERIALS, EQUIPMENT AND SERVICE NECESSARY TO COMPLETE ALL MASONRY WORK AS INDICATED OR SPECIFIED. 2. RELATED WORK SPECIFIED ELSEWHERE: MASONRY WALL INSULATING AND FILL, FACE CAULKING OF CONTROL

3. MATERIALS: CONCRETE MASONRY UNITS SHALL CONFORM TO ASTM C-90, GRADE U-1, FC M=1350 P.S.I. 4. CONSTRUCTION AND WORKMANSHIP:

4.1 THE WORK SHALL BE DONE BY EXPERIENCED MECHANICS. SKILLED IN THEIR TRADE. IN A FIRST CLASS MANNER. 4.2 THE CONTRACTOR SHALL BE RESPONSIBLE FOR QUALITY OF WORKMANSHIP AND FOR COMPLIANCE WITH THE DESIGN AND SPECIFICATIONS. HE SHALL CORRECT ALL ERRORS AND DEVIATIONS AS REQUESTED BY THE ARCHITECT.

4.3 TRANSPORT AND HANDLE ALL MASONRY UNITS IN SUCH MANNER AS TO PREVENT CHIPPING AND BREAKAGE. PROTECT ALL MASONRY FROM INCLEMENT WEATHER EFFECTS AND HEAVY AND UNNECESSARY TRAFFIC. 4.4 DO NOT LAY CHIPPED CRACKED OR OTHERWISE DEFECTIVE UNITS IN THE WALL

4.5 ALL JOINTS SHALL BE AS INDICATED ON DRAWINGS, STRAIGHT, TRUE, AND UNIFORM IN THICKNESS TO COURSE

4.6 ALL MASONRY SHALL BE RUNNING BOND UNLESS INDICATED OTHERWISE.

4.7 PROVIDE ALL OPENINGS IN MASONRY WALLS WHERE REQUIRED OR INDICATED. BUILD IN ALL ITEMS AS REQUIRED FOR A COMPLETE JOB. INCLUDING (BUT NOT LIMITED TO) REINFORCING STEEL. BOLTS. ANCHORS. CONDUITS AND

4.8 CLEAN ALL FINISHED MASONRY WALLS FOR A NEAT CLEAN AND FINISHED APPEARANCE, IF EXPOSED TO VIEW. 4.9 INSTALL HORIZONTAL JOINT REINFORCEMENT IN WALL JOINTS AT 16" ON CENTER VERTICAL.

DIVISION 6 - CARPENTRY AND MILLWORK:

1. SCOPE: ALL ROUGH AND FINISH CARPENTRY WORK AND MILL WORK AS INDICATED ON DRAWINGS AND SPECIFIED. THE INSTALLATION OF ALL ROUGH AND FINISH HARDWARE, SHELVING AND TRIM, HANGER AND ALL MATERIAL NECESSARY TO COMPLETE ALL THE FRAMING AND FINISH WORK AS SHOWN. INSTALL ALL BLOCKING, FIRE STOPS, BACKING, BRIDGING, ETC., FOR THE PROPER INSTALLATION OF ALL APPLIED ITEMS. 2. RELATED WORK SPECIFIED ELSEWHERE: FINISHES.

DIVISION 16 - ELECTRICAL

1. SCOPE: FURNISH, INSTALL AND CONNECT COMPLETE ELECTRICAL SYSTEMS AS SHOWN ON THE DRAWINGS, SPECIFIED OR OTHERWISE NECESSITATED BY THE WORK, INCLUDING, BUT NOT NECESSARILY LIMITED TO:ELECTRICAL SERVICE ENTRANCE AND METERING. COMPLETE ELECTRIC DISTRIBUTION SYSTEM FOR LIGHTING AND POWER. WIRING AND RELATED WORK FOR: MECHANICAL SYSTEMS, MOTORS, PUMPS, TELEPHONE, CABLE T.V. ROUGH IN, AND EQUIPMENT 2. RELATED WORK SPECIFIED ELSEWHERE: EXCAVATION, FILLING AND BACKFILLING, MECHANICAL AND PLUMBING

3. CONSTRUCTION AND WORKMANSHIP: ALL WORK AND MATERIALS SHALL COMPLY WITH THE FOLLOWING ASMINIMUM STANDARDS. A.THE NATIONAL ELECTRIC CODE, LATEST EDITION B.THE NATIONAL ELECTRIC MANUFACTURERS ASSOCIATION STANDARDS

C.THE NATIONAL ELECTRICAL SAFETY CODE

D.THE INSULATED POWER CABLE ENGINEERS ASSOCIATION STANDARDS E.UNDERWRITERS LABORATORIES INCORPORATED STANDARDS

4 GENERAL REQUIREMENTS 4.1 ALL OUTLETS SHALL BE GROUNDED

4.3 ALL GROUNDING SHALL BE IN ACCORDANCE WITH THE NATIONAL ELECTRIC CODE. GROUND ROD AND ASSEMBLY SUPPLIED AND **INSTALLED BY CONTRACTOR**

4.4 LIGHTING FIXTURES, EQUIPMENT, ETC., SHALL BE AS SCHEDULED OR OTHERWISE INDICATED ON THE DRAWINGS. 4.5 THE CONTRACTOR SHALL GUARANTEE THE ENTIRE INSTALLATION (EXCEPT LAMPS) FOR A PERIOD OF ONE (1) YEAR FROM THE DATE OF FINAL ACCEPTANCE

PANELS: SQUARE "D" OR EQUAL PANELS WITH RAIN TIGHT ENCLOSURE WHEN USED OUTDOORS. ROMEX 12-2 WITH GROUND AND METAL BOXES ARE PERMITTED, UNLESS OTHERWISE SPECIFIED ON THE DRAWINGS. INSTAL WITH

4.6 MATERIALS AND EQUIPMENT SHALL COMPLY WITH THE APPLICABLE CURRENT STANDARDS OF UNDERWRITERS LABORATORIES

FEEDERS TO BE (2) 1/0 THW W/ (1) THW IN 4" CONDUIT. OR AS NOTED ON DRAWINGS

CONDUIT TO BE P.V.C. PROVIDE STUB ONLY. WIRING DEVICES SHALL BE LEVITON, RESIDENTIAL GRADE WHITE, OR APPROVED EQUAL.

4.7 CONTRACTOR SHALL FURNISH LIGHTING FIXTURES AND FANS IN CONTRACT AS CALLED FOR ON THE FIXTURE SCHEDULE SHOWN ON THE DRAWINGS. IN THE ABSENCE OF A FIXTURE SCHEDULE,. FIXTURES WILL BE AS SELECTED BY THE OWNER AND PAID BY THE OWNER AS A NEGOTIATED EXTRA TO THE CONTRACT. THE OWNER RESERVES THE RIGHT TO FURNISH FIXTURES SHOWN FOR 777 INSTALLATION IN LIEU OF PURCHASING THEM THROUGH THE CONTRACTOR. 4.8 CONTRACTOR SHALL FURNISH AND INSTALL APPROVED HARD-WIRED SMOKE DETECTORS IN ACCORDANCE WITH THE

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PROJECT NUMBER DRAWN: KM/TSN CHECKED: PMP DATE: <u>09-19-2016</u>

SHEET#


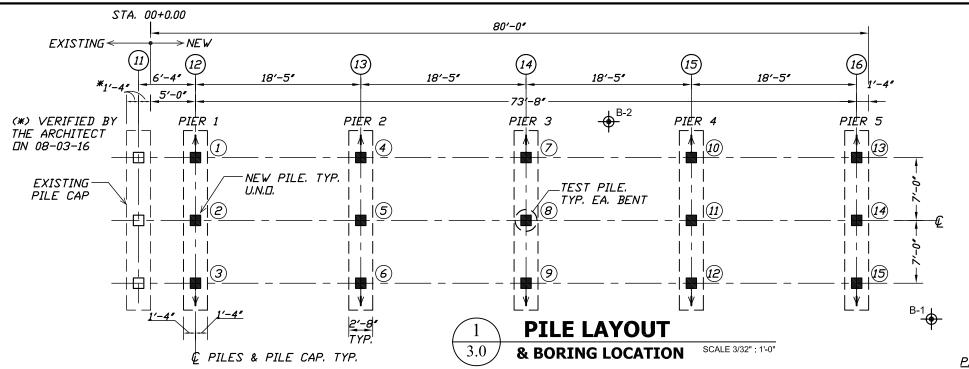


TABLE 1 - PILE DESIGN, PRODUCTION AND INSTALLATION CRITERIA						PILE DESIGN CRITERIA					
Pier	Station	Nominal	Min.	Mud	Тор	Req'd	Test	#	Factored	Resistance	Pile
or	at	Bearing	Tip	Line	of	Preform	Pile	S	Design	Factor	Cutoff
Bent	Gridline	Resistance	Elev.	Elev.	Rock	Elev.	Length	17 E	Loads		Elev.
#	(ft)	(tons)	(ft)	(ft)	(ft)	(ft)	(ft)	۵	(tons)	Ø	(ft)
1	0+05.000	TBD<60	-30.0	-14	-16.0	-26.0	<i>35</i>	3	TBD<39	0.65	2.783
2	0+23.417	60	-30.0	-14	-16.0	-26.0	35	3	39	0.65	2.783
3	0+41.833	60	-30.0	-14	-16.0	-26.0	35	3	39	0.65	2.783
4	0+60.250	60	-30.0	-14	-16.0	-26.0	35	3	39	0.65	2.783
5	0+78.667	TBD<60	-30.0	-14	-16.0	-26.0	35	3	TBD<39	0.65	2.783



3.0

SCALE 3/32": 1'-0"

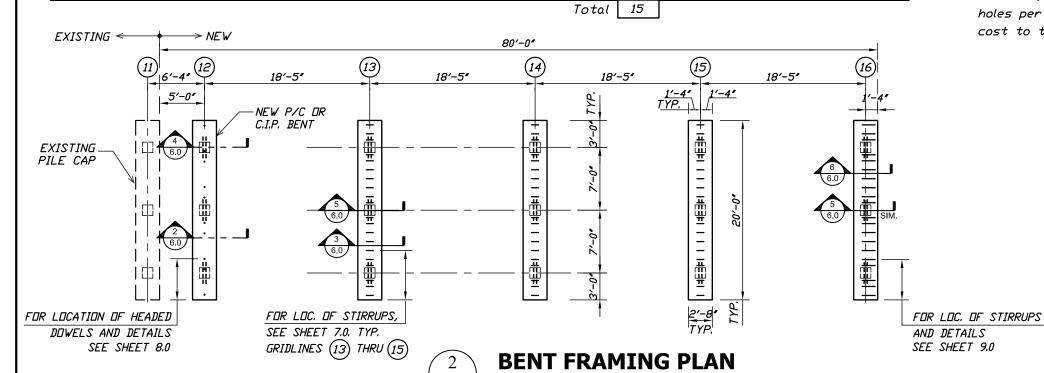

SYMBOLS :

: 14" × 14" EXISTING VERTICAL PILES

14" × 14" VERTICAL PILES

14" × 14" BATTERED PILES

APROX. BORING LOC.

PILE INSTALLATION NOTES:

The minimum tip elevation is required for lateral stability.

Drive all Test Piles in the position of a permanent pile and monitor according to the geotechnical recommendations and section 455-5.13 of the FDOT specifications.

Pilot holes or preformed holes shall be drilled using a drill diameter not to exceed 18". If oversize holes are used, the contractor shall grout the preformed holes per SSRBC Section 455-5.9.5 at not additional cost to the owner.


M. CORDERO & ASSOCIATES STRUCTURAL ENGINEERS CA# 6278


PETER PIKE ASSOCIATES
Architects - Planners - Consultant
471 US HIGHWAY I SUITE 101
KEY WEST, FL 33040


LAYOUT & BENT FRAMING PLAN


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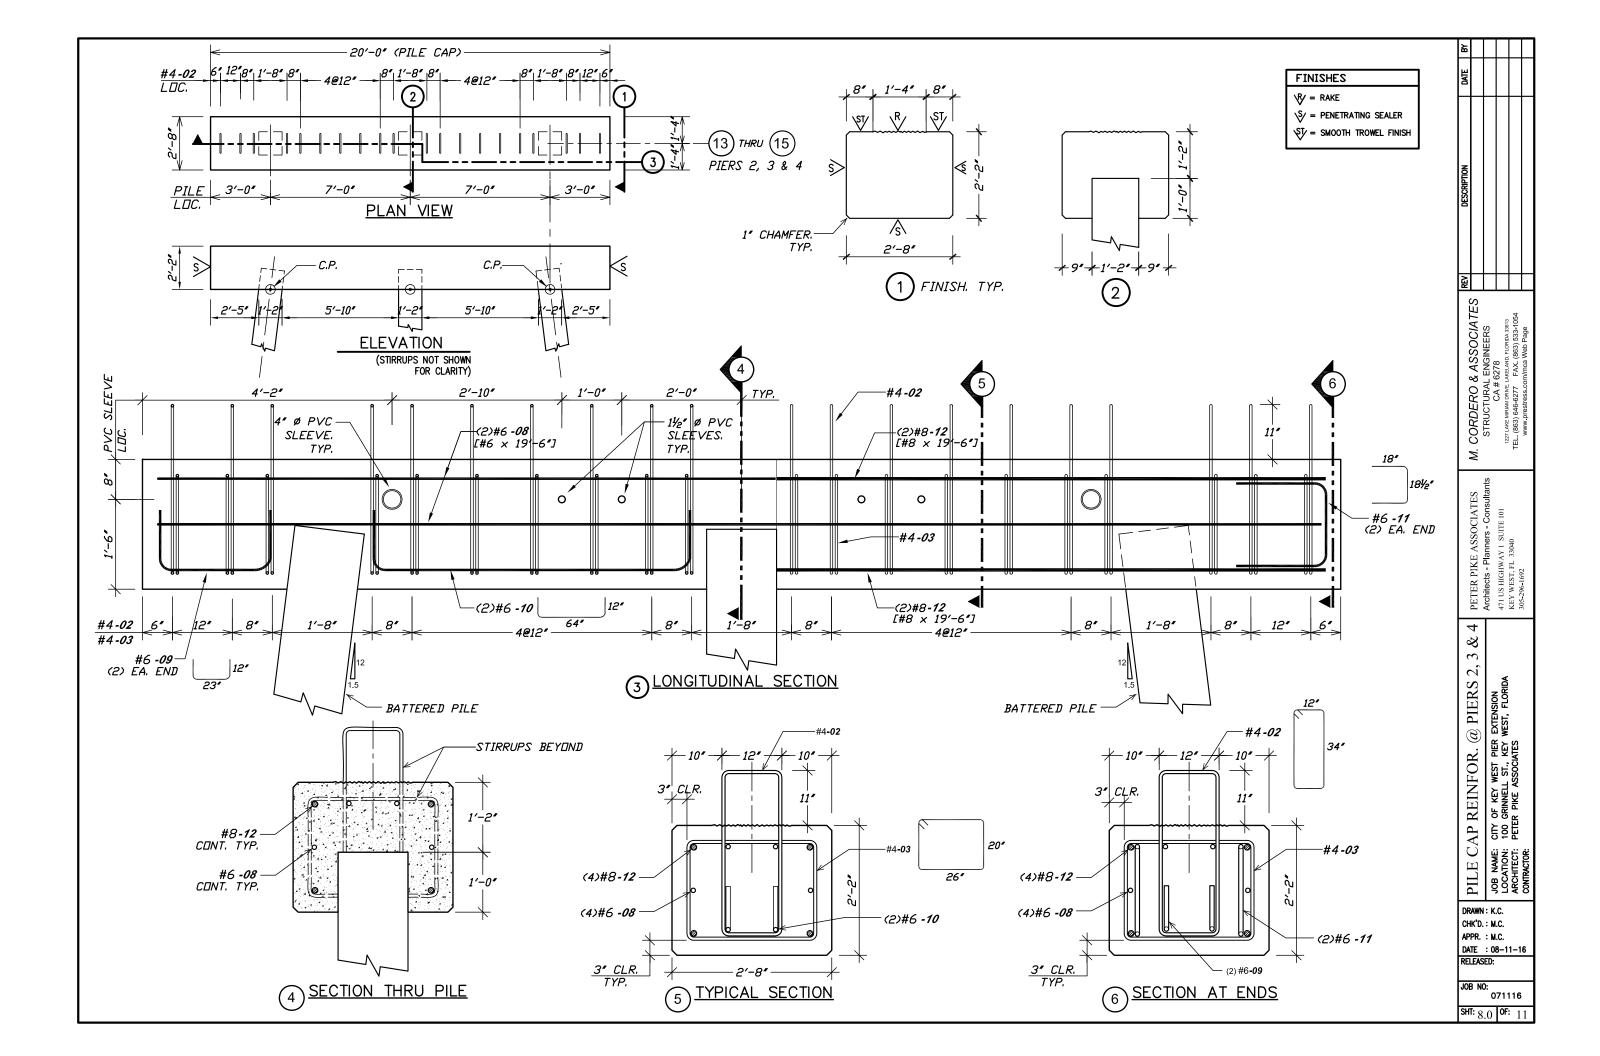
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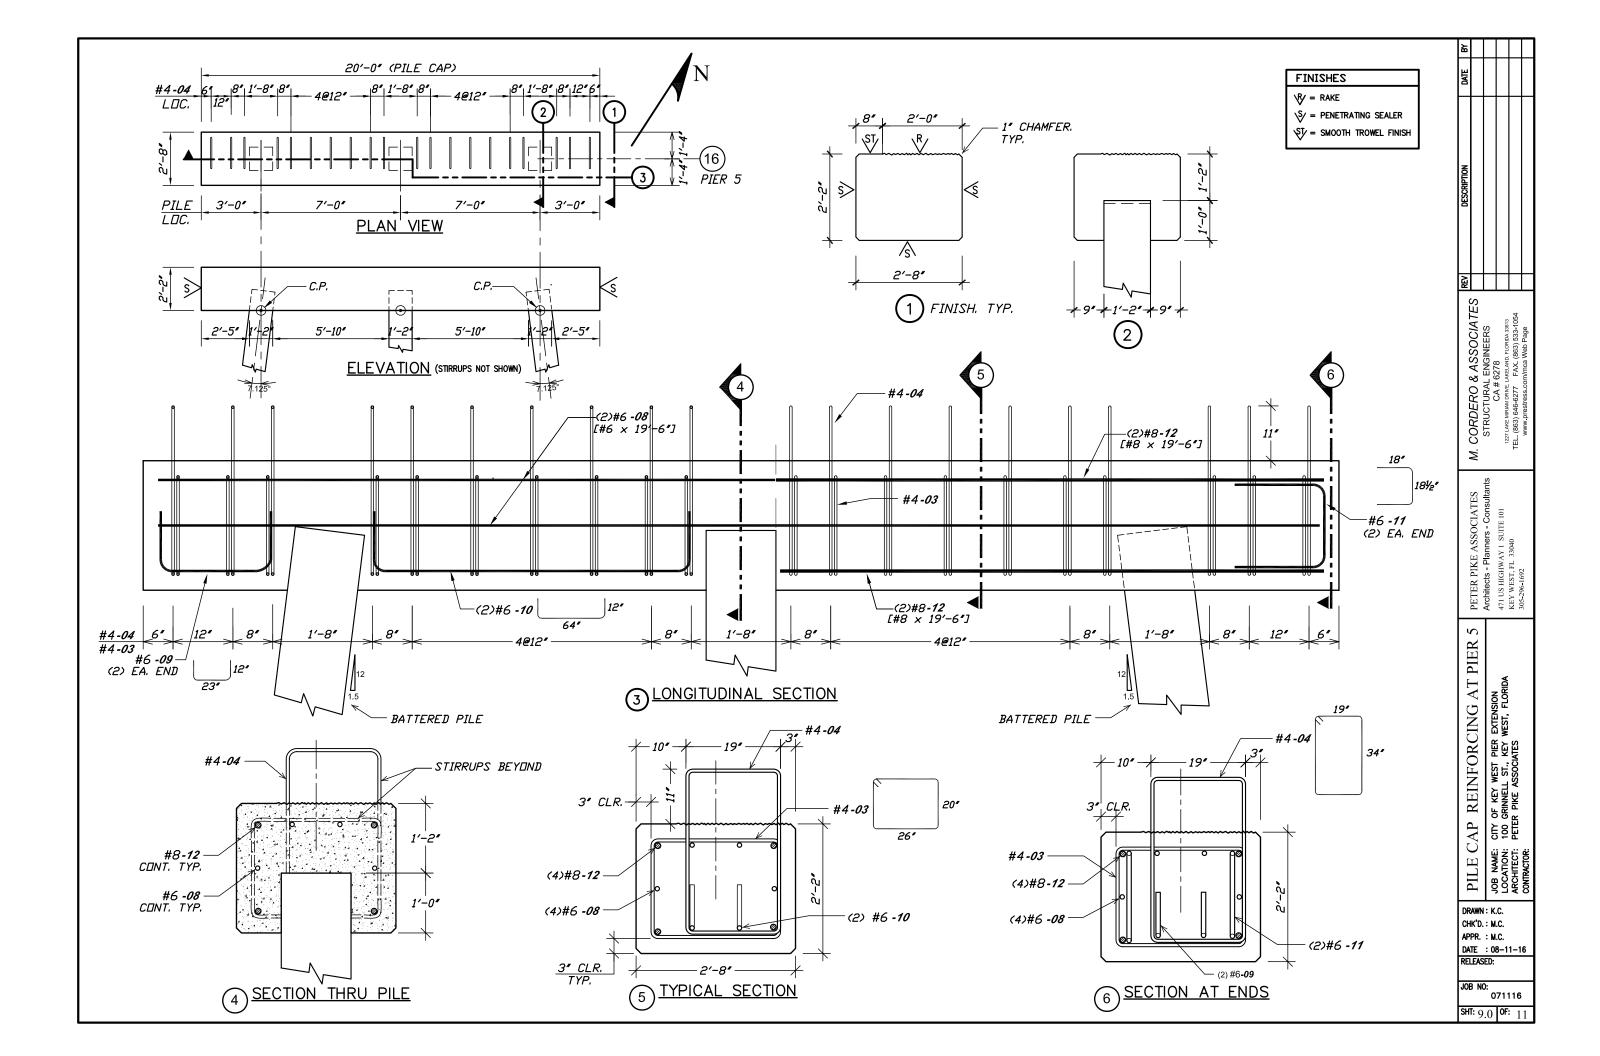





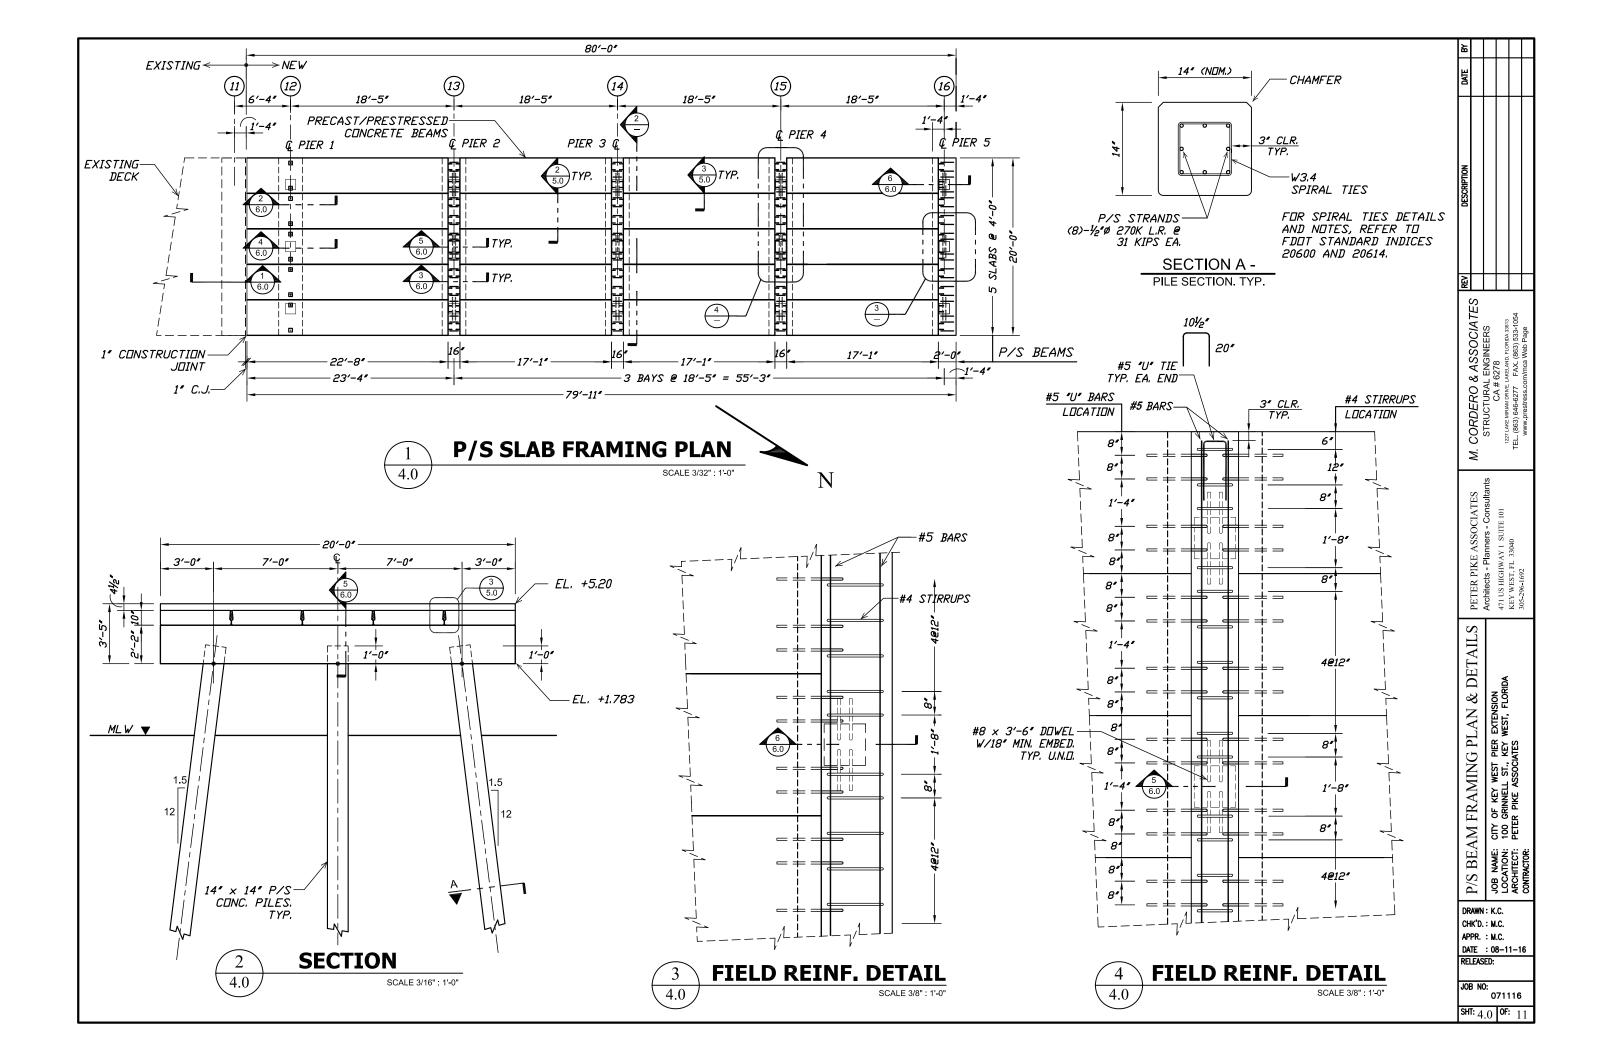


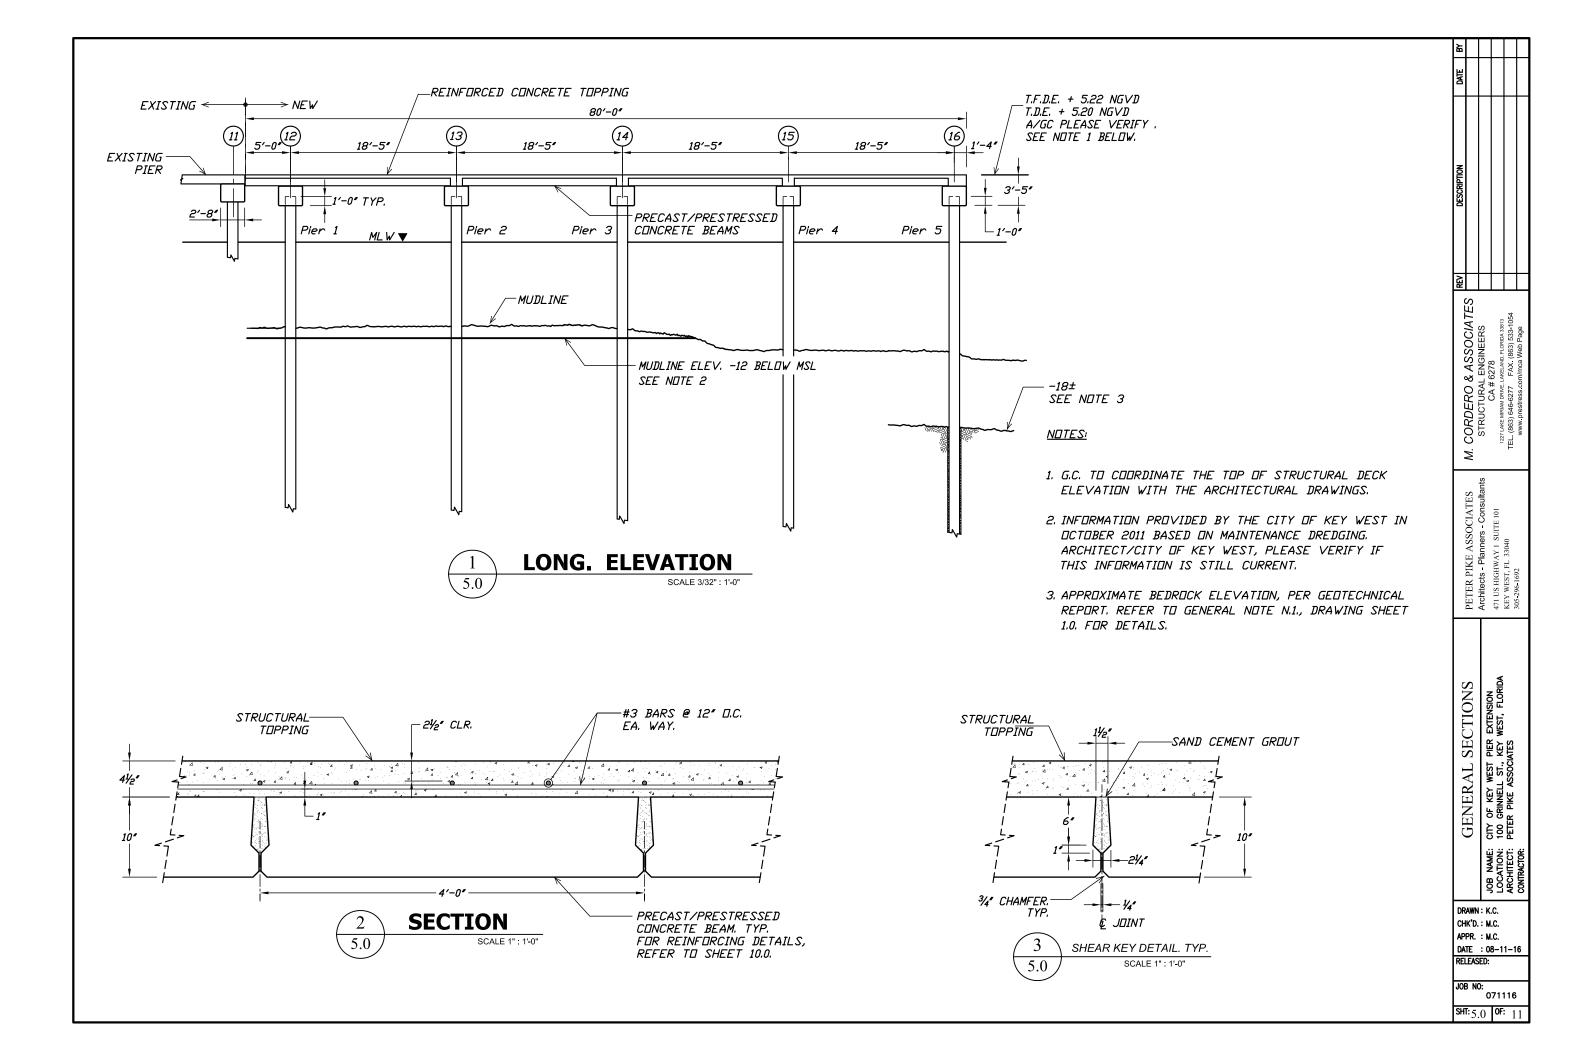

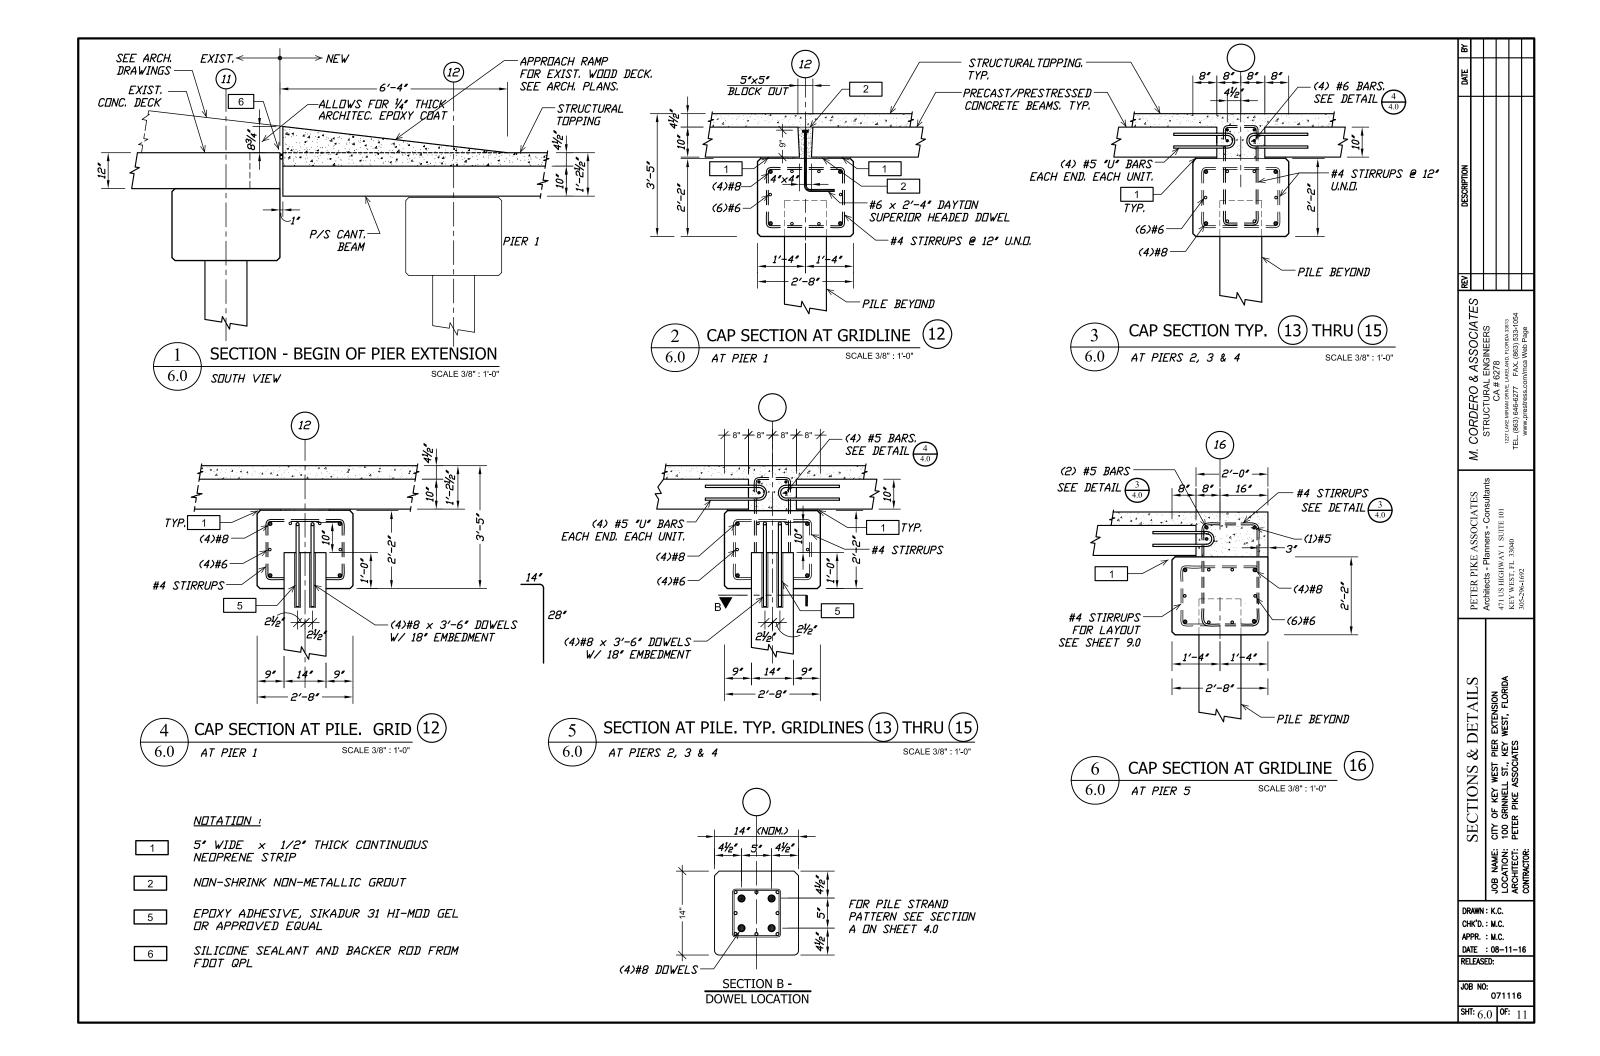

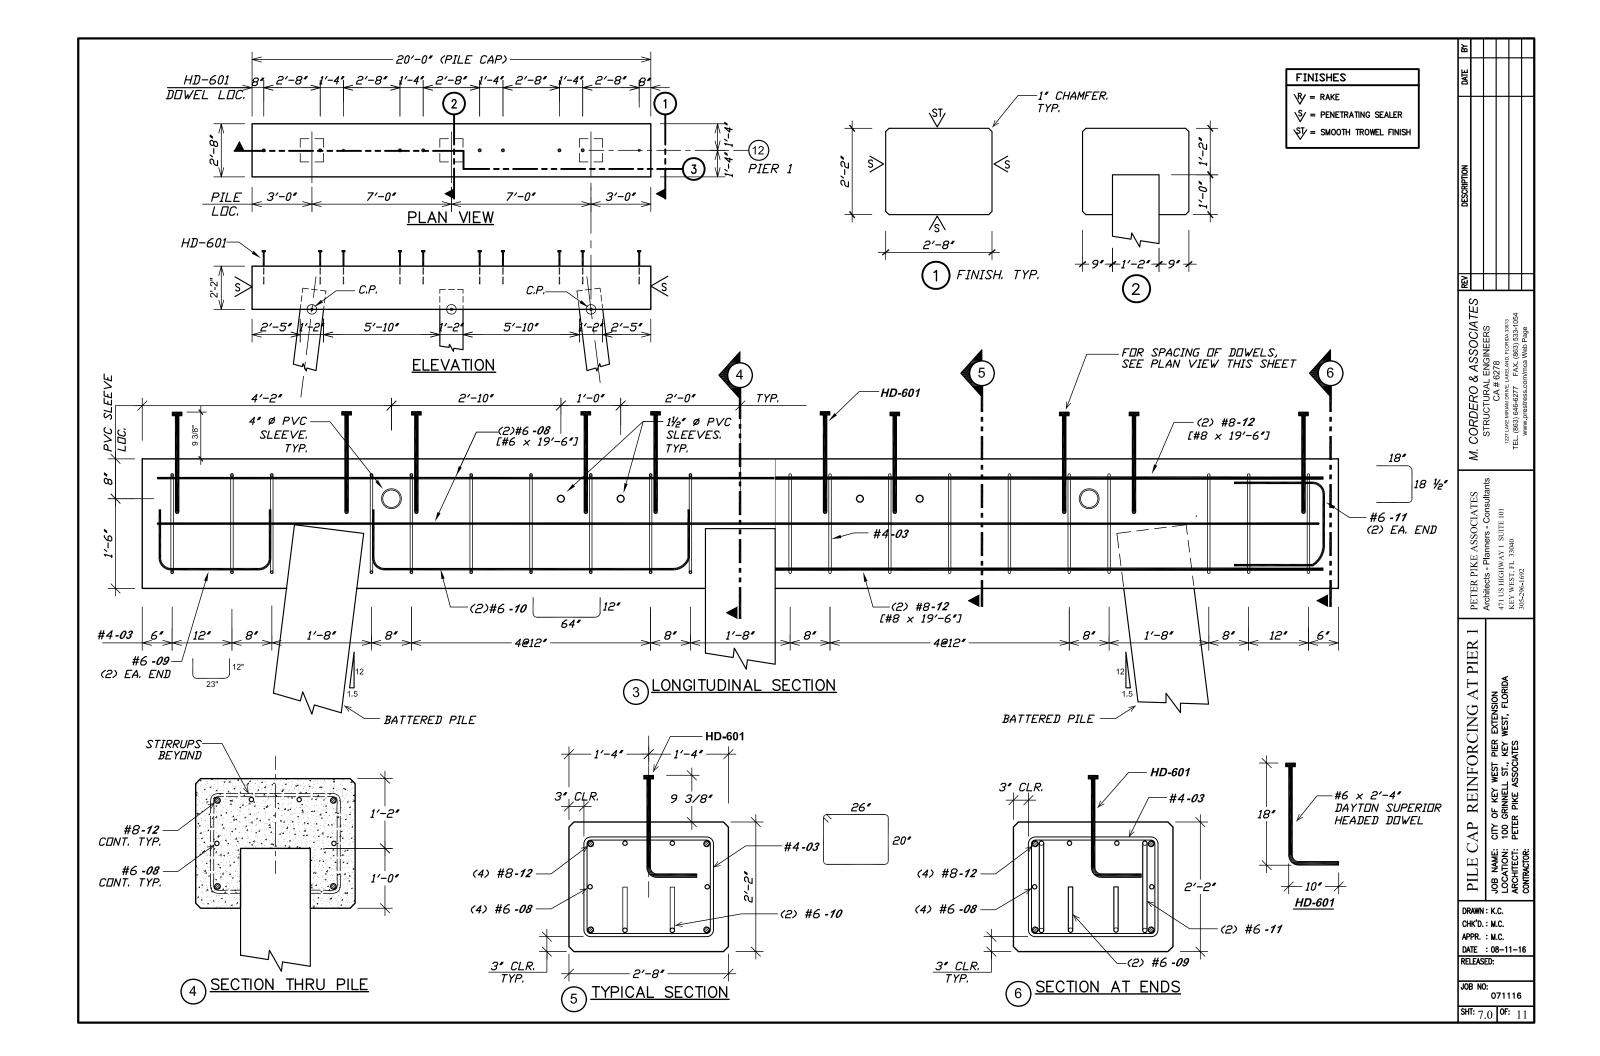

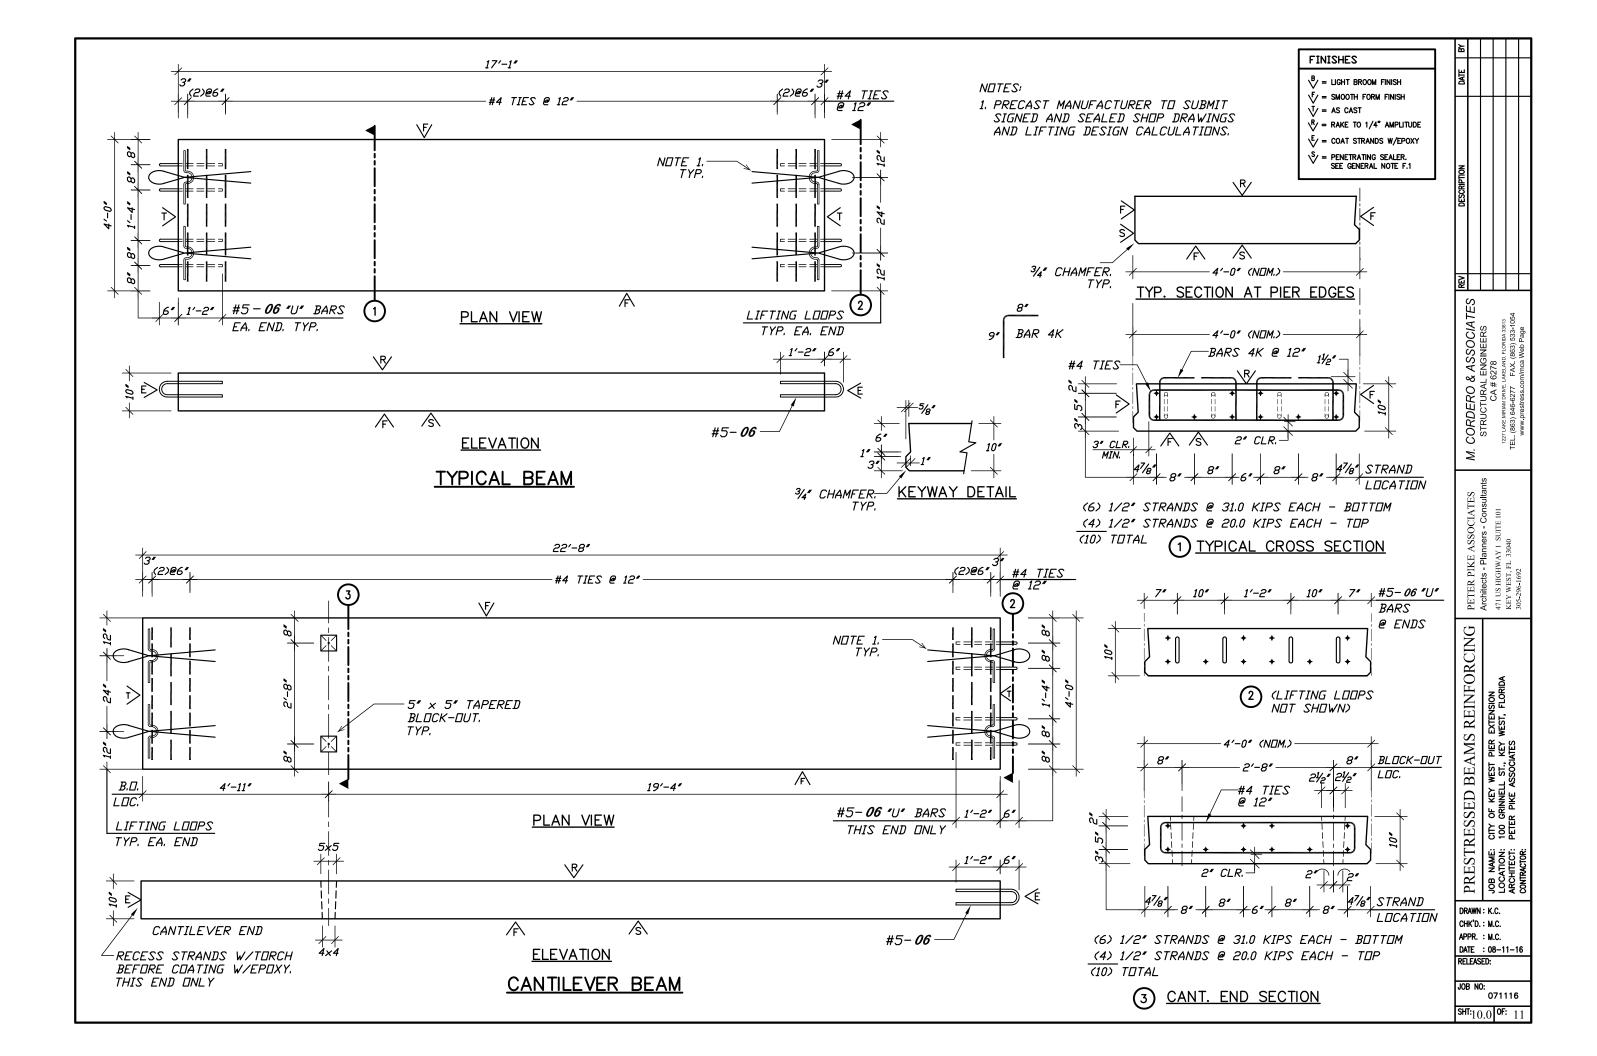

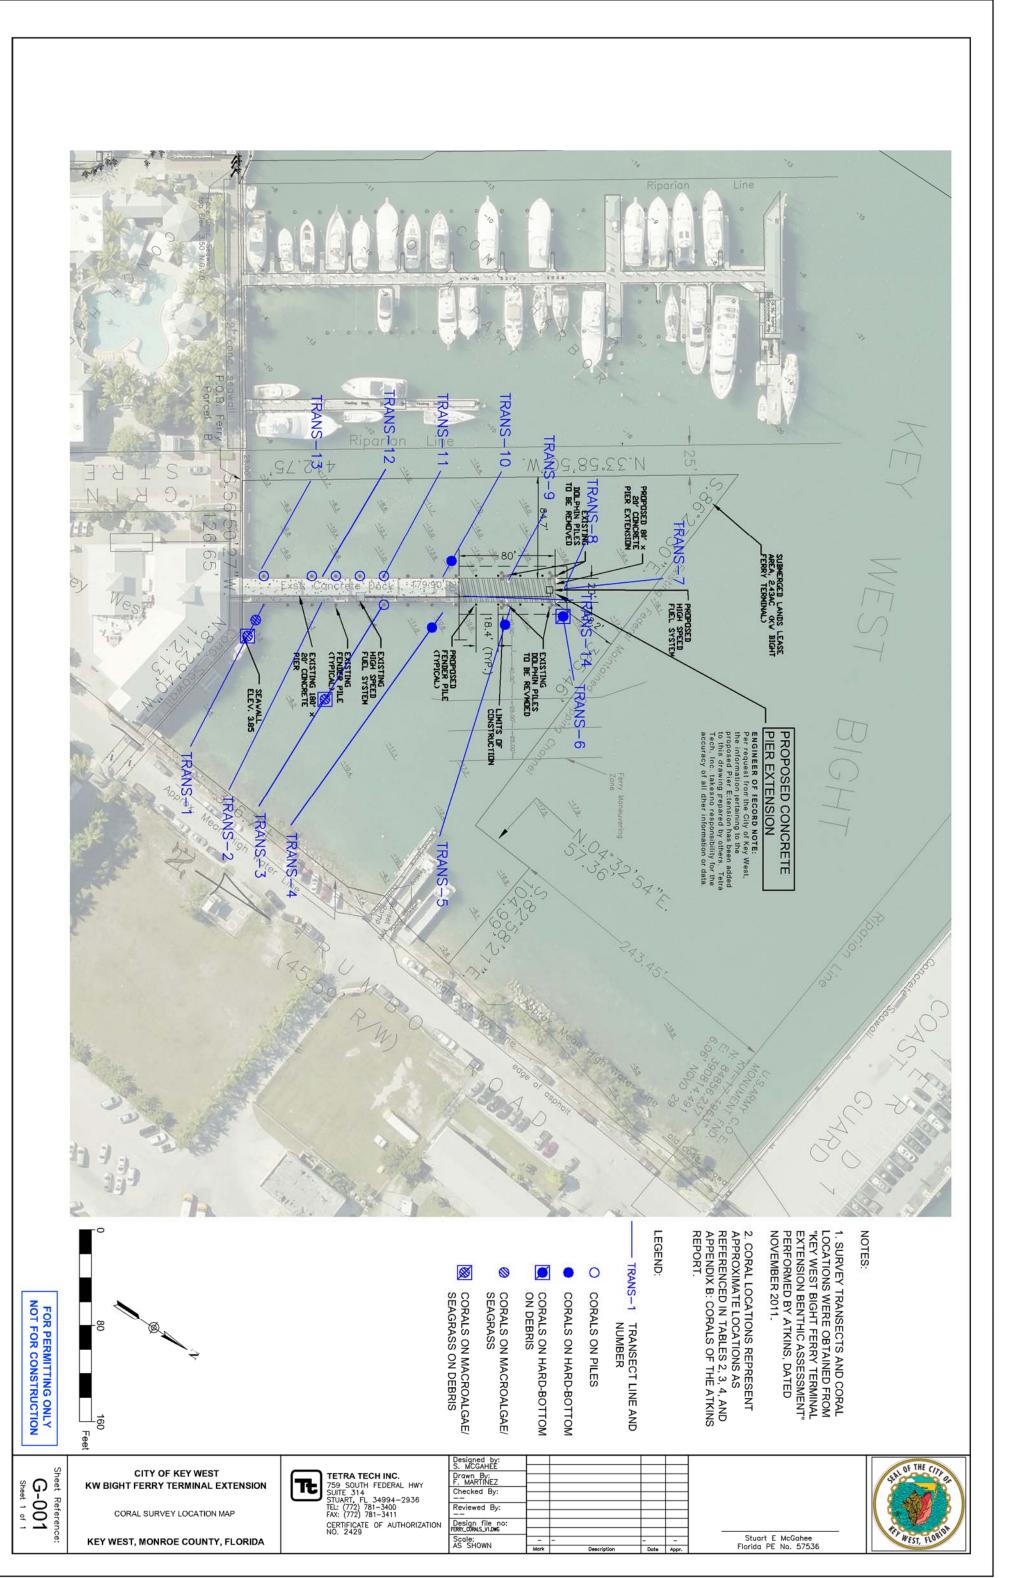

FOR PERMITTING ONLY
NOT FOR CONSTRUCTION

Sheet Reference:
G-006
Sheet 6 of 6

CITY OF KEY WEST
KW BIGHT FERRY TERMINAL EXTENSION

FERRY TERMINAL EXTENSION AND AERIAL

KEY WEST, MONROE COUNTY, FLORIDA



Designed by: S. MCGAHEE				
Drawn By: F. MARTINEZ				
Checked By:				
Reviewed By:	\vdash			
Design file no: FERRY_DESIGN_V1.DWG				
Scale: AS SHOWN	-	-	-	-



Stuart E McGahee Florida PE No. 57536

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